New Construction: Eastside Gateway Project - 2 Bedrooms East Michigan Ave. Between Forseman Ave. & Phelps Ave. Kalamazoo, MI 49048

Kalamazoo County Land Bank Authority 1523 RIVERVIEW DRIVE KALAMAZOO, MI 49004

project team

In·Formarchitecture

architecture - interior design 401 e. michigan ave., suite 100 kalamazoo, mi 49007 269.270.3331 www.informarchitect.com

Nehil Sivak

structural engineering 414 s burdick st. suite 300 kalamazoo, michigan, 49007 269.383.3111

drawing index

C2.0A LAYOUT PLAN

C3.0A GRADING AND SESC PLAN

C4.0A DETAILS

L1.0A LANDSCAPE PLAN

A1.0 GENERAL NOTES

A1.1 BASEMENT & MAIN LEVEL PLANS

A1.2 GARAGE PLANS, ELEVATIONS AND DETAILS

A2.1 REFLECTED CEILING PLAN & ROOF PLANS

A3.1 EXTERIOR ELEVATIONS

A4.1 BUILDING SECTIONS

A5.1 WALL SECTIONS

A6.1 INTERIOR ELEVATIONS


FRAMING PLANS

MECHANICAL PLAN

MECHANICAL NOTES

project name **EASTSIDE GATEWAY** PROJECT - 2 BEDROOMS project number 18016 issue date FOR PRICING 7.3.18

IN-FORM

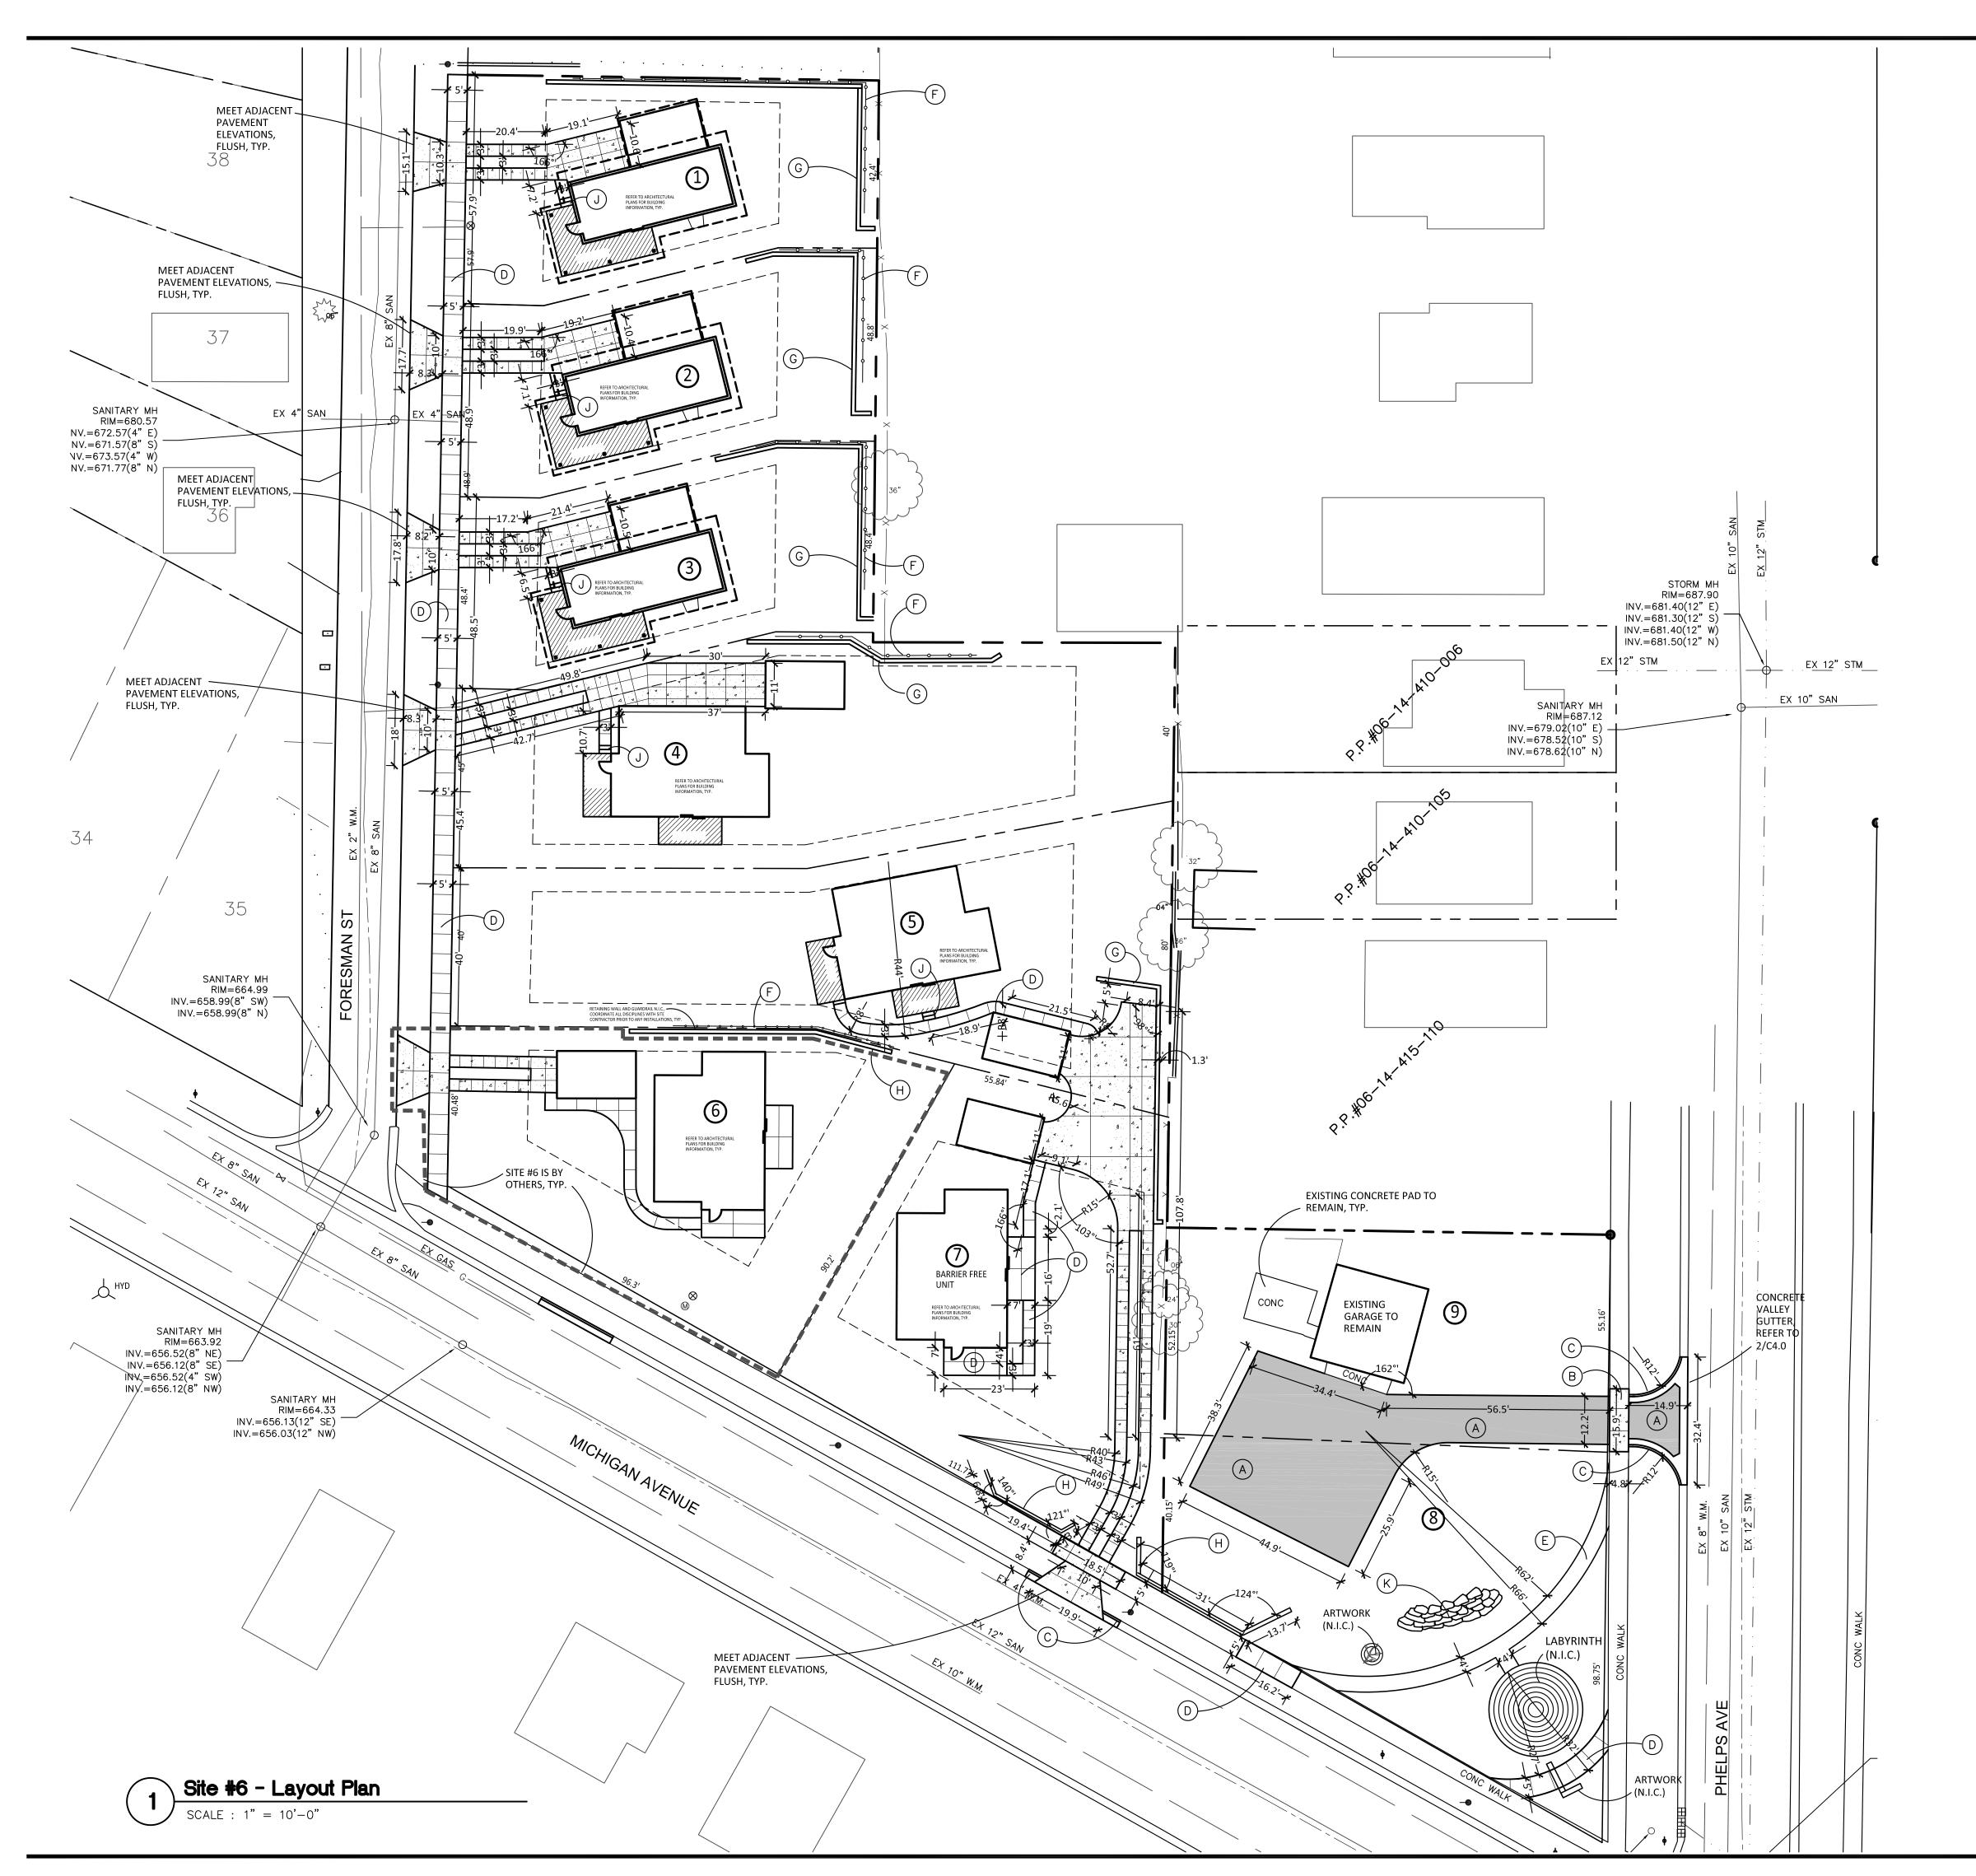

LAYOUT NOTES:

1. SURVEY OF EXISTING CONDITIONS PROVIDED BY FLEIS AND VANDENBRINK, 4798 CAMPUS DRIVE, KALAMAZOO MI 49008 PH: 269-385-0011

2. PAVEMENT DIMENSIONS AND RADII ARE TO EDGE OF PAVEMENT OR BACK OF CURB.

3. DISCREPANCIES BETWEEN SITE AND PLANS SHOULD BE REPORTED TO THE PROJECT MANAGER IMMEDIATELY.

4. VERIFY LOCATIONS OF ALL BELOW GRADE UTILITIES PRIOR TO BEGINNING WORK. 72 HOURS BEFORE YOU DIG CALL "MISS DIG" AT

5. SITE LAYOUT POINTS SHOULD BE ESTABLISHED AND PROTECTED FOR FUTURE SITE WORK.


6. FINAL PROPOSED LOT DIMENSIONS ARE PENDING PER LOT LAYOUT APPROVAL BY THE CITY OF KALAMAZOO AND FINAL LEGAL DESCRIPTIONS.


7. PROJECT SITE IS LOCATED IN THE 10 YEAR WELL HEAD CAPTURE ZONE.

8. WATER SERVICE TO EACH UNIT TO BE 3/4" DIA WITH 3/4" METER.

9. SANITARY LEAD TO BE 4" DIA SDR35 WITH CLEAN OUT.

PROPOSED FEATURES LEGEND:

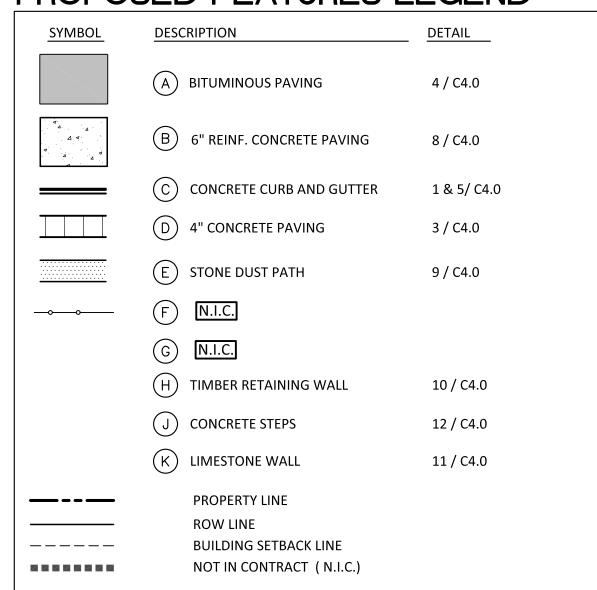


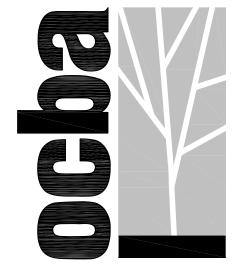

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Issued For:

Date

FINAL SITE PLAN REVIEW
6-6-18

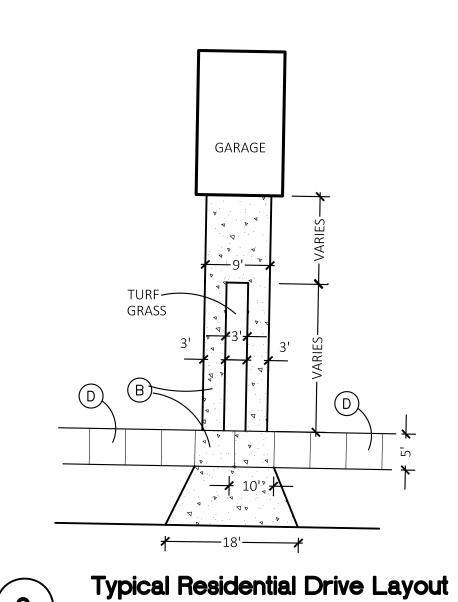ISSUED FOR BID - GRADING
6-8-18

ISSUED FOR BID - SITE #6 PCK.
07/02/18

ISSUED FOR BID - SITES #1,2,3,4,5,7,8, & 9
07-03-18

Project:

Kalamazoo East Side Gateway Project


NOT TO SCALE

Kalamazoo, MI

Sheet Title

Layout Plan




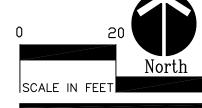

Job No.

Sheet No.

41708

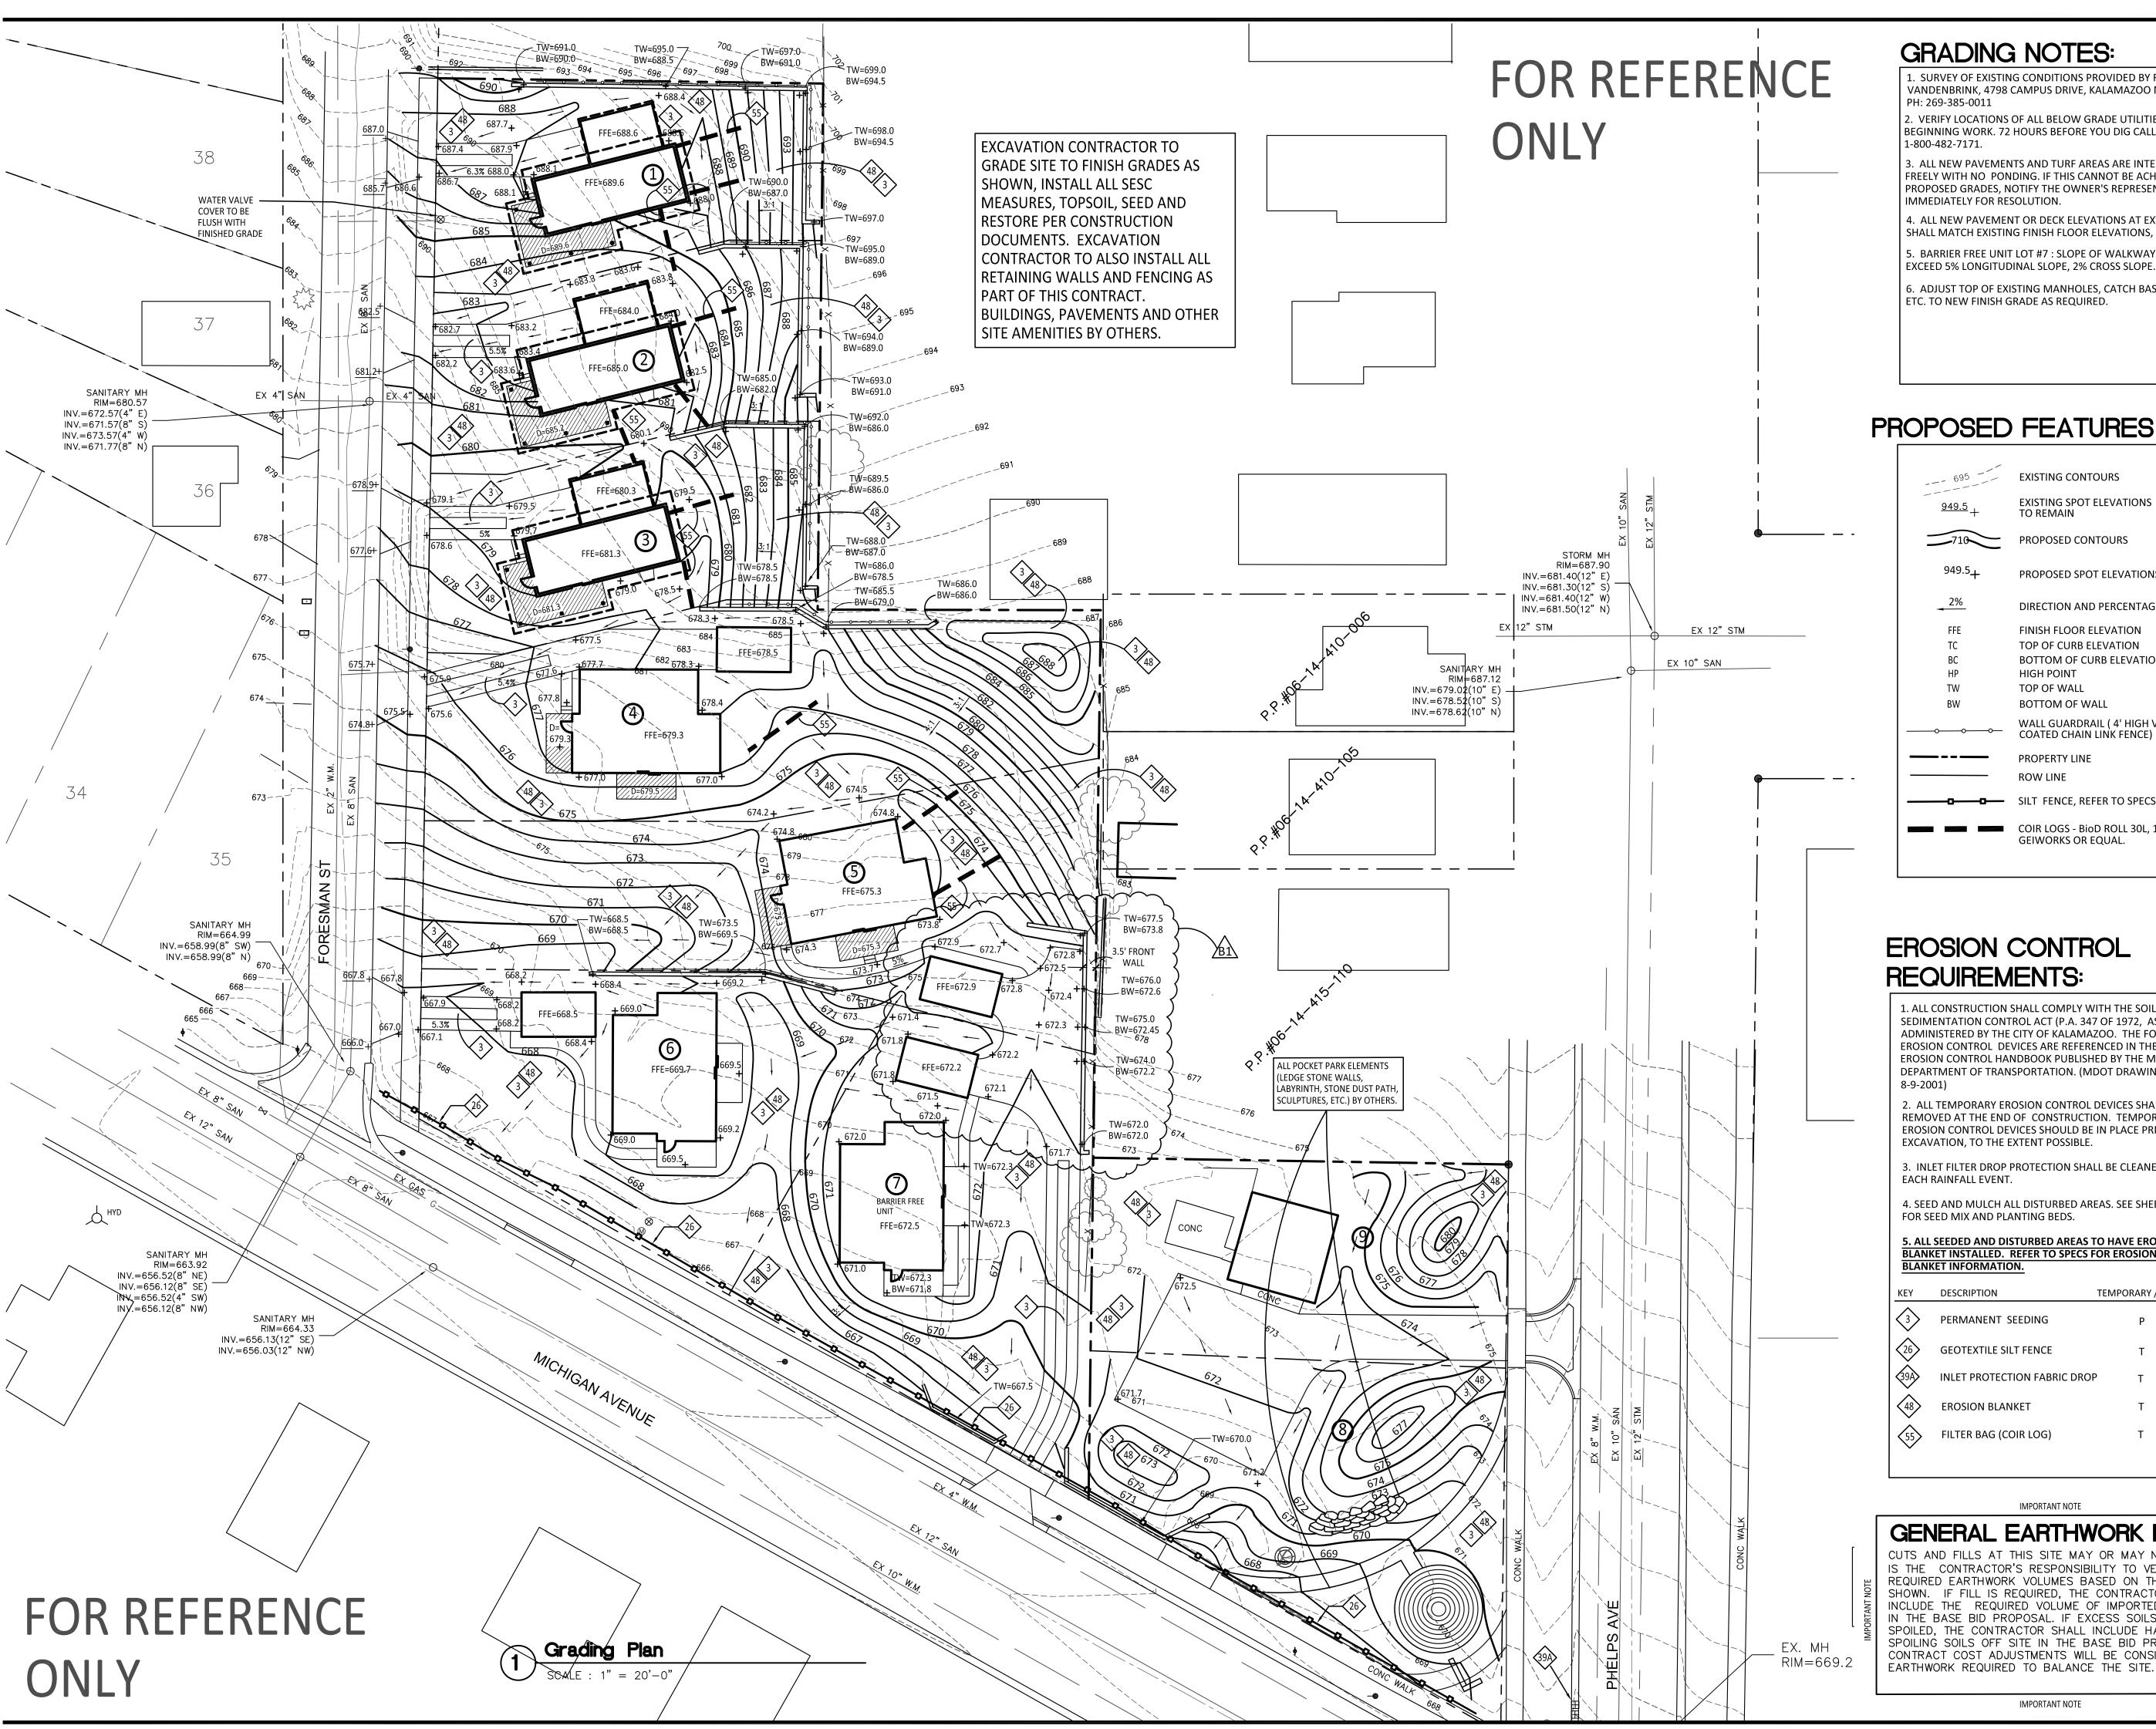

GRADING NOTES:

1. SURVEY OF EXISTING CONDITIONS PROVIDED BY FLEIS AND VANDENBRINK, 4798 CAMPUS DRIVE, KALAMAZOO MI 49008

2. VERIFY LOCATIONS OF ALL BELOW GRADE UTILITIES PRIOR TO BEGINNING WORK. 72 HOURS BEFORE YOU DIG CALL "MISS DIG" AT

3. ALL NEW PAVEMENTS AND TURF AREAS ARE INTENDED TO DRAIN FREELY WITH NO PONDING. IF THIS CANNOT BE ACHIEVED USING THE PROPOSED GRADES, NOTIFY THE OWNER'S REPRESENTATIVE IMMEDIATELY FOR RESOLUTION.

4. ALL NEW PAVEMENT OR DECK ELEVATIONS AT EXTERIOR DOORS SHALL MATCH EXISTING FINISH FLOOR ELEVATIONS, TYPICAL.

5. BARRIER FREE UNIT LOT #7 : SLOPE OF WALKWAYS TO UNIT NOT TO

6. ADJUST TOP OF EXISTING MANHOLES, CATCH BASINS, VAULT COVERS, ETC. TO NEW FINISH GRADE AS REQUIRED.

PROPOSED FEATURES LEGEND:

EXISTING CONTOURS EXISTING SPOT ELEVATIONS TO REMAIN 949.5_{_} PROPOSED CONTOURS PROPOSED SPOT ELEVATIONS DIRECTION AND PERCENTAGE OF SLOPE FINISH FLOOR ELEVATION TOP OF CURB ELEVATION BOTTOM OF CURB ELEVATION HIGH POINT TOP OF WALL **BOTTOM OF WALL** WALL GUARDRAIL (4' HIGH VINYL COATED CHAIN LINK FENCE) PROPERTY LINE SILT FENCE, REFER TO SPECS AND DETAIL 7/C4.0 COIR LOGS - BioD ROLL 30L, 12" DIA BY GEIWORKS OR EQUAL.

EROSION CONTROL REQUIREMENTS:

1. ALL CONSTRUCTION SHALL COMPLY WITH THE SOIL EROSION AND SEDIMENTATION CONTROL ACT (P.A. 347 OF 1972, AS AMENDED) AS ADMINISTERED BY THE CITY OF KALAMAZOO. THE FOLLOWING EROSION CONTROL DEVICES ARE REFERENCED IN THE STANDARD EROSION CONTROL HANDBOOK PUBLISHED BY THE MICHIGAN DEPARTMENT OF TRANSPORTATION. (MDOT DRAWING R-96-C,

2. ALL TEMPORARY EROSION CONTROL DEVICES SHALL BE REMOVED AT THE END OF CONSTRUCTION. TEMPORARY EROSION CONTROL DEVICES SHOULD BE IN PLACE PRIOR TO **EXCAVATION, TO THE EXTENT POSSIBLE**

3. INLET FILTER DROP PROTECTION SHALL BE CLEANED AFTER EACH RAINFALL EVENT.

4. SEED AND MULCH ALL DISTURBED AREAS. SEE SHEET L1.0 FOR SEED MIX AND PLANTING BEDS.

5. ALL SEEDED AND DISTURBED AREAS TO HAVE EROSION BLANKET INSTALLED. REFER TO SPECS FOR EROSION CONTROL **BLANKET INFORMATION.**

ANENT

IMPORTANT NOTE

GENERAL EARTHWORK NOTE:

REQUIRED EARTHWORK VOLUMES BASED ON THE GRADING PLAN INCLUDE THE REQUIRED VOLUME OF IMPORTED CLASS II SAND IN THE BASE BID PROPOSAL. IF EXCESS SOILS NEED TO BE SPOILED, THE CONTRACTOR SHALL INCLUDE HAULING AND SPOILING SOILS OFF SITE IN THE BASE BID PROPOSAL. NO CONTRACT COST ADJUSTMENTS WILL BE CONSIDERED FOR EARTHWORK REQUIRED TO BALANCE THE SITE.

IMPORTANT NOTE

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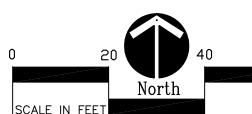
OTHER SIZES.	
ssued For:	Date
TINAL SITE PLAN REVIEW	6-6-18
SSUED FOR BID — GRADING	6-8-18
SSUED FOR BID - SITES #1,2,3,4,5,7,8, &	9 07-03-1
B1 BULLETIN No. 1	07-06-18

Kalamazoo East Side **Gateway Project**

Kalamazoo, MI


Sheet Title

Grading and SESC Plan




Job No.


C3.0A

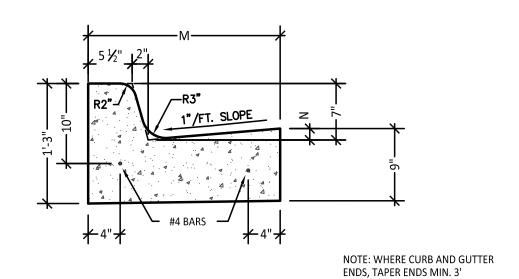

MDOT Type C Curb + Gutter

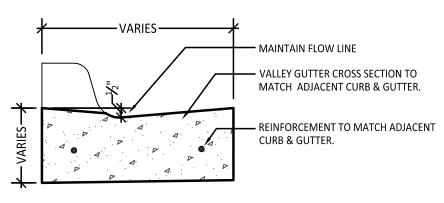

Section-Valley Gutter

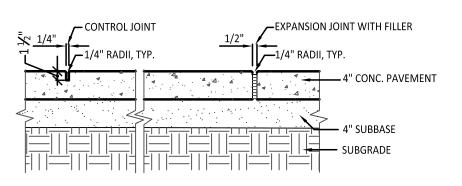

GEOTEXTILE FILTER FABRIC FASTENED ON UPHILL SIDE, TOWARDS EARTH DISRUPTION

- TOP OF WALL

3"-6" THICK LIMESTONE
TO MATCH EXISTING

INSTALL 2 STONE COURSES BELOW FINISH GRADE

— FINISH GRADE VARIES, REFER TO GRADING PLAN

_6"X 6" ANCHOR TRENCH

SECTION A-A

Section-Conc. Paving + Jointing

COUPLER

SECTION B-B

-SPACING 6' MAX.-

GEOTEXTILE FABRIC

6" ANCHOR TRENCH

1' MIN.

UNDISTURBED VEGETATION—

Silt Fence Detail

SILT FENCE JOINT SILT FENCE A

SILT FENCE A

FRONT VIEW

FINISHED GRADE 2" BELOW WALL -

8" DEPTH PLANTING SOIL -

CONTINUOUS -GEOTEXTILE FABRIC

CLASS II GRANULAR BACKFILL, TYP.


EXISTING SUBGRADE

4" GEOTEXTILE WRAPPED, PERFORATED HDPE PIPE— CONNECTED INTO


STORMWATER SYSTEM

6" MDOT 6A STONE


SILT FENCE B

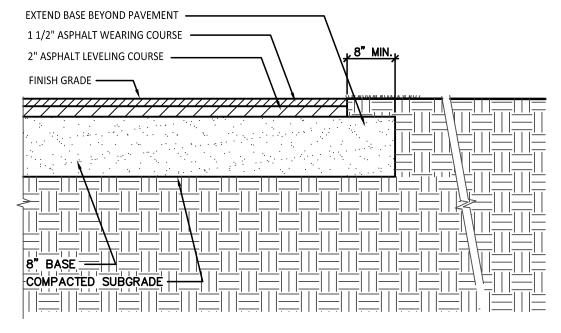


Section-Asphalt Pavement Moderate Duty

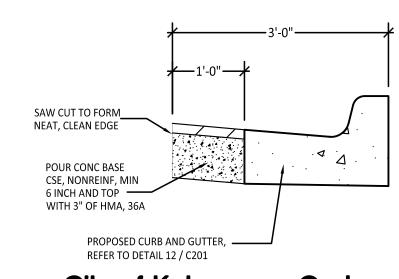

City of Kalamazoo Curb and Gutter Replacment Detail

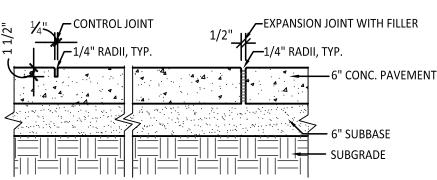


6' Thick Conc. Pavement

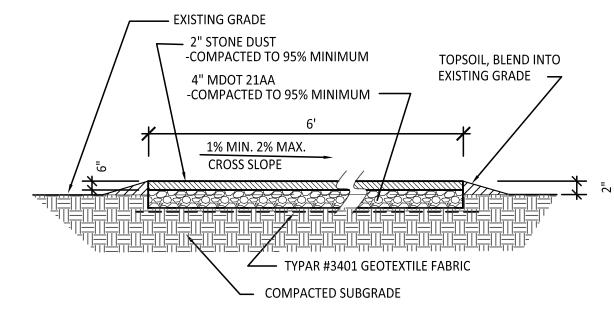



Stone Dust Path



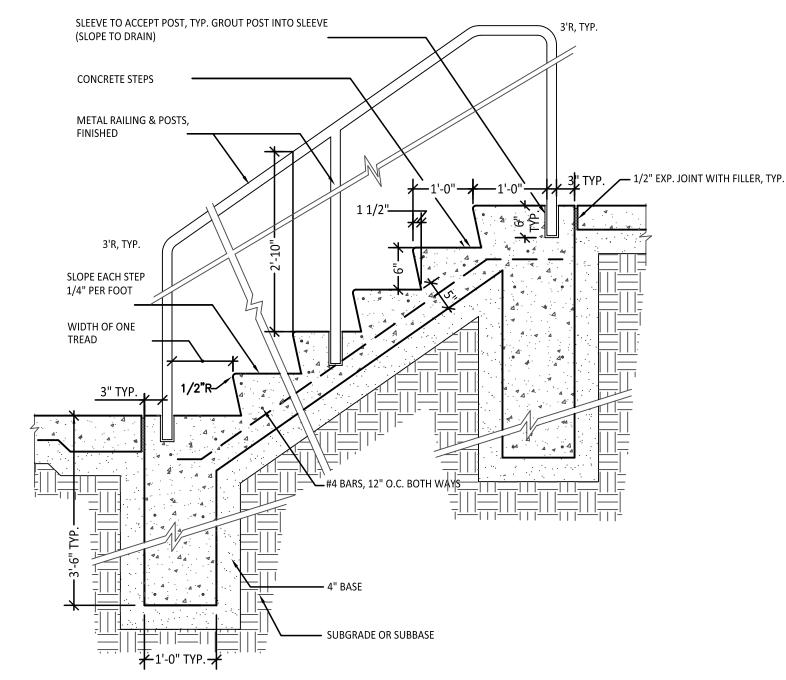


Section - Step + Railing Detail

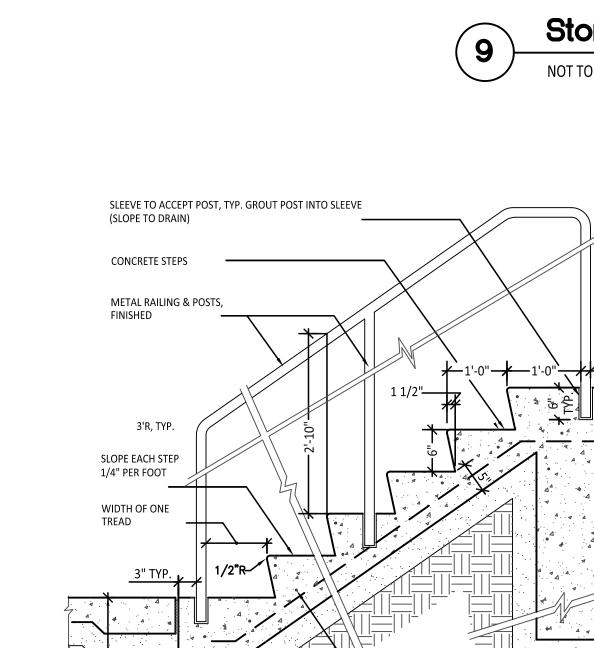

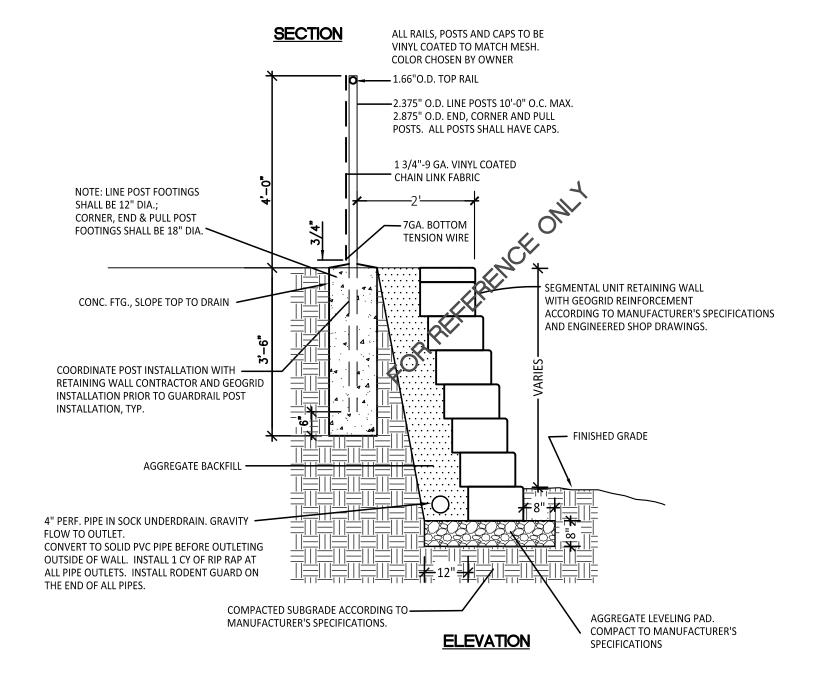

Segmental Unit Retaining Wall and Guardrail

Not to Scale 1. COLOR : TO BE CHOSEN BY OWNER 2. CONTRACTOR IS TO SUBMIT ENGINEERED SHOP DRAWINGS OF SEGMENTAL UNIT RETAINING WALL PREPARED BY A REGISTERED P.E. IN THE STATE OF MICHIGAN TO THE LANDSCAPE ARCHITECT FOR APPROVAL PRIOR TO CONSTRUCTION OF WALLS. 3. INSTALL WALL ACCORDING TO MANUFACTURER'S SPECIFICATIONS.

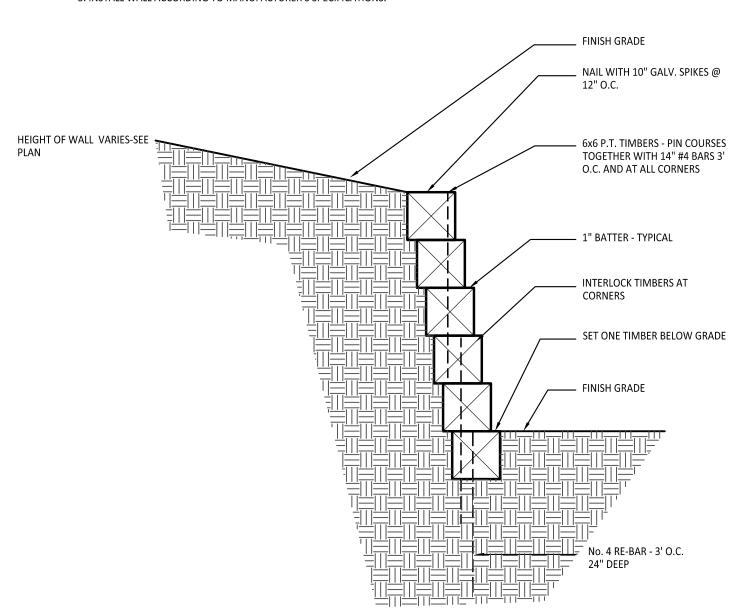

Wolminized Timber Retaining Wall

Limestone Retaining Wall

Details

Sheet Title

Project:

Kalamazoo

Kalamazoo, MI

Gateway Project

East Side

Job No.

41708

C4.0A

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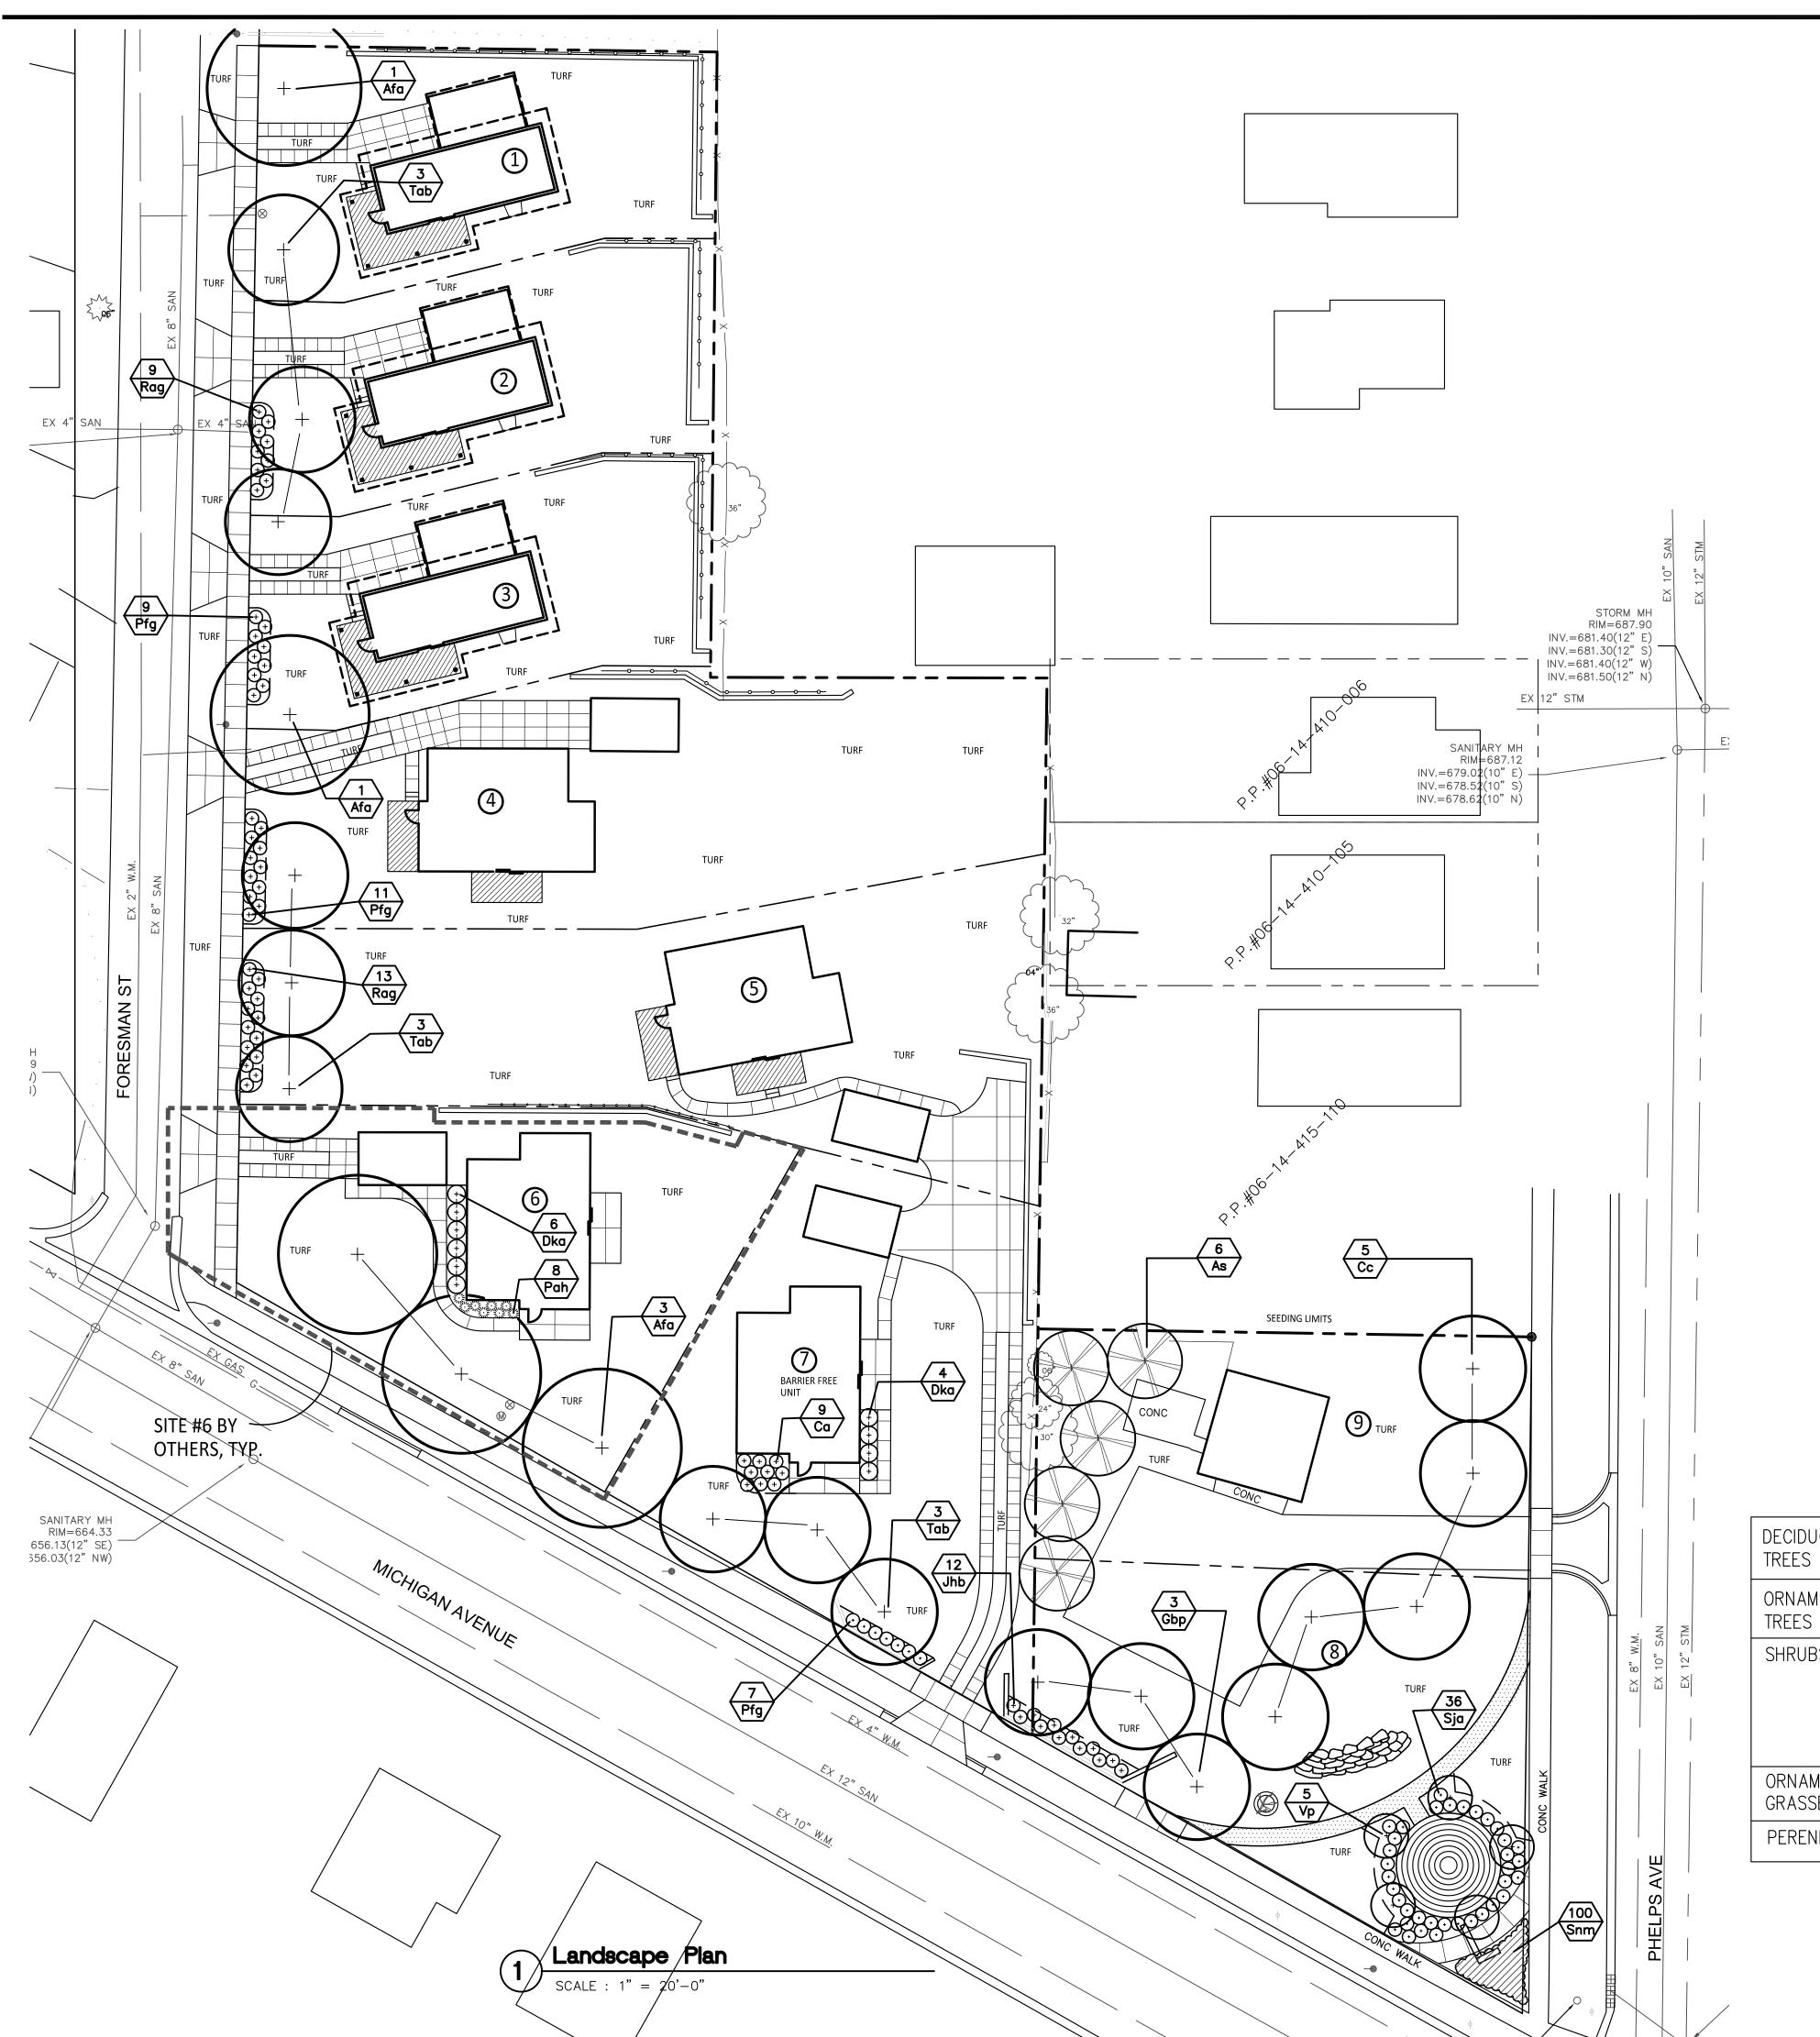
ISSUED FOR BID - GRADING 6-8-18

6-6-18


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FINAL SITE PLAN REVIEW

Urban Planning





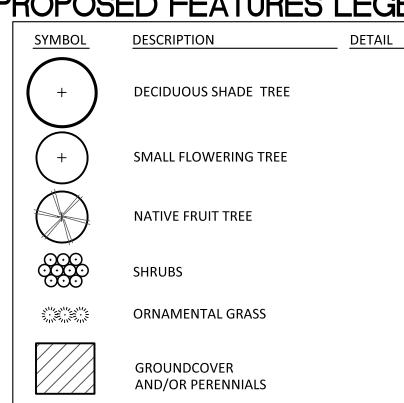

— — METAL LANDSCAPE EDGING

6 Bn MAINTAINED BY CONTRACTOR.

PLANT TAG- REFERS TO TYPE AND NUMBER OF PLANTINGS TO BE PROVIDED AND

LANDSCAPE NOTES:

1. SURVEY OF EXISTING CONDITIONS PROVIDED BY FLEIS AND VANDENBRINK, 4798 CAMPUS DRIVE, KALAMAZOO MI 49008 PH: 269-385-0011

2. CALL "MISS DIG" AND VERIFY ALL UNDERGROUND UTILITIES PRIOR TO BEGINNING WORK. 72 HOURS BEFORE YOU DIG CALL "MISS DIG" AT 1-800-482-7171. ANY UTILITIES DISTURBED BY CONSTRUCTION SHALL BE REPAIRED AT CONTRACTOR'S EXPENSE.

3. ANY DISCREPANCIES BETWEEN THESE PLANS AND ACTUAL FIELD CONDITIONS SHOULD BE REPORTED TO THE CONSTRUCTION MANAGER IMMEDIATELY FOR RESOLUTION.

4. IN AREAS OF NEW TURF PLACE 4" MINIMUM TOPSOIL, FINE GRADE & ESTABLISH TURF WITHIN SEED LIMIT

LINES. TURF SEED MIX: ECO-TURF LOW MAINTENANCE FESCUE MIX by:

MICHIGAN WILDFLOWER FARM, 11770 CUTLER ROAD PORTLAND, MICHIGAN 48875 ph: 517-647-6010 www.MICHIGAN WILDFLOWER FARM.COM OR APPROVED EQUAL.

INSTALL EROSION BLANKET ON ALL TURF AREAS. SEE SPECIFICATIONS. REFER TO SHEET C3.0

5. PLACE SHREDDED HARDWOOD MULCH TO A 3" DEPTH IN ALL TREE & SHRUB BEDS & TO A 2" DEPTH IN ALL GROUND COVER BEDS.

6. UNLESS OTHERWISE NOTED, TOPSOIL, FINE GRADE AND SEED ALL DISTURBED AREAS WITHIN THE SEEDING LIMIT SHOWN AND AREAS DISTURBED BY CONSTRUCTION.

7. REPAIR AND RESTORE ANY DAMAGE OUTSIDE OF LIMIT OF WORK LINE TO ORIGINAL

3. PROTECT ALL TREES AND EXISTING FEATURES TO REMAIN AS SPECIFIED.

9. ALL TOPSOIL AND EXCESS FILL MATERIAL SHALL BE STOCKPILED ON SITE SEPARATELY FOR LATER RE-USE. LOCATE STOCKPILES IN AREAS AS DIRECTED BY CONSTRUCTION MANAGER AND PROTECT FROM EFFECTS OF EROSION.

10. ALL NURSERY STOCK SHALL BE TRUE TO TYPE AND NAME. ALL STOCK SHALL BE FIRST CLASS QUALITY WITH WELL DEVELOPED BRANCH SYSTEMS AND VIGOROUS HEALTHY ROOT SYSTEMS. ALL STOCK SHALL BE WELL FORMED AND THE TRUNKS OF TREES SHALL BE UNIFORM AND

11. UNLESS OTHERWISE SPECIFIED, ALL PERENNIALS, GRASSES AND GROUNDCOVERS SHALL BE GROWN IN THEIR CONTAINER FOR ONE YEAR PRIOR TO INSTALLATION.

12. LANDSCAPE REQUIREMENTS

FORESMAN STREET : FRONTAGE = 281 LFT TREES: 281 / 35 = 8 SHRUBS : 281 / 20 = 14 (3) = 42

EAST MICHIGAN AVENUE: FRONTAGE=336 LFT TREES: 336 / 35 = 10 SHRUBS: 336 / 20 = 17 (3) = 51

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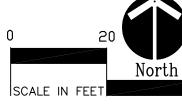
PLANT LIST:

	SYM.	BOTANICAL NAME	COMMON NAME	SIZE	ROOT	COM.
DECIDUOUS SHADE TREES	Afa Gbp Tab	Acer x freemani 'Autumn Blaze' Ginko biloba 'Princeton Sentry' Tilia americana 'Boulevard'	Autumn Blaze Maple Princeton Sentry Ginko Boulevard American Linden	2.5" cal. 2.5" cal. 2.5" cal.	B&B B&B B&B	
ORNAMENTAL TREES	At Cc	Asimina triloba Cercis canadensis	Paw Paw Eastern Redbud	1.5" cal 2" cal.	cont B&B	
SHRUBS	Ca Dko Jhb Pfg Rag Sja Vp	Cotoneaster apiculata Diervilla x 'Kodiak Orange' Juniperus horizontalis 'Blue Chip' Potentilla fruticosa 'Goldfinger' Rhus aromatica 'Grow—Lo' Spiraea japonica 'Alpina' Viburnum prunifolium	Cranberry Cotoneaster Kodiak Orange Diervilla Blue Chip Juniper Goldfinger Potentilla Grow—Lo Sumac Daphne Spiraea Blackhaw Viburnum	18" Ht. 18" Ht. 24" Spread 18" Ht. 18" Ht. 12" Ht. 36" Ht.	Cont. Cont. Cont. Cont. Cont. Cont. Cont. Cont.	3' O.C. 4' O.C. 3' O.C. 4' O.C. 4' O.C. 3' O.C. Tree Form
ORNAMENTAL GRASSES	Pah	Pennisetum alopecuroides 'Hameln'	Hameln Fountain Grass	2 Gal.	Cont.	2'-6"O.C.
PERENNIALS	Snm	Salvia nemerosa 'May Night'	May Night Salvia	1 Gal.	Cont.	18" O.C.

Kalamazoo East Side **Gateway Project**

Kalamazoo, MI

Landscape Plan



Job No.

L1.0A

41708

1. MISCELLANEOUS:

a.DIMENSIONS ARE GIVEN TO FACE OF SIP PANEL OR STUD.

b. GENERAL CONTRACTOR TO NOTIFY ARCHITECT OF ANY DISCREPANCY OF DIMENSION OR EXISTING CONDITION, AND FOR CLARIFICATION AS NEEDED.

c.PROJECT TO MEET ALL REQUIREMENTS OF 2015 MICHIGAN RESIDENTIAL CODE AS INTERPRETED BY THE CITY OF KALAMAZOO BUILDING OFFICIAL.

d.PROJECT TO COMPLY WITH ENERGY STAR REQUIREMENTS, DEPARTMENT OF ENERGY ZERO-ENERGY-READY REQUIREMENTS, AND INDOOR AIR PLUS REQUIREMENTS TO ACHIEVE CERTIFICATION. THESE REQUIREMENTS EXCEED MINIMUM REQUIREMENTS OF MICHIGAN UNIFORM ENERGY CODE. NOTE: PROJECT TO BE BID AS SHOWN IN DRAWINGS; OWNER TO RETAIN RATER TO EVALUATE COMPLIANCE.

e. "WATER-SENSE" GUIDELINES TO BE FOLLOWED, BUT CERTIFICATION WILL NOT BE SOUGHT.

f. A "THERMAL ENCLOSURE CHECKLIST" MUST BE COMPLETED BEFORE DRYWALL

g.ALL MATERIALS, CAULKS, ADHESIVES AND SEALANTS MUST BE LOW OR NO VOC TO MEET INDOOR AIR PLUS REQUIREMENTS.

2. DEMOLITION:

a.CLEAR SITE OF DEBRIS AS NEEDED

3. FOUNDATION:

a.FOUNDATION AT HOUSE AND GARAGE TO BE SUPERIOR WALL SYSTEM XI — ENGINEERED AND INSTALLED BY AUTHORIZED DISTRIBUTOR. GARAGE FOUNDATION IS NOT REQUIRED TO BE INSULATED. ENGINEER TO COORDINATE WITH SPECIFIC SITE CONDITIONS AT EACH SITE; CONDITIONS VARY AND MAY REQUIRE STEM WALL AT PORTIONS OF FOUNDATION. SEE DOCUMENTS FOR TWO-BEDROOM LAYOUT FOR STEM WALL DETAIL. EXCAVATION CONTRACTOR TO COORDINATE WITH SUPERIOR WALL SYSTEM SUPPLIER FOR FOOTING AND FLOOR

b.FOUNDATION AT DECK TO BE 16" DIAMETER SONOTUBES. BOTTOM OF FOUNDATION TO BE AT FROST LINE.

c.PROVIDE RADON SYSTEM; VENT IN SAME AREA AS PLUMBING STACK. LOCATE FAN IN ATTIC ABOVE CORRIDOR/BATH AREA.

4. FLOORS:

a.FLOOR CONSTRUCTION OF BASEMENT OF HOUSE TO BE 4" CONCRETE SLAB ON VAPOR BARRIER ON 2" RIGID INSULATION (UNDER ENTIRE SLAB) ON CLEAN CRUSHED STONE FOOTING. CRUSHED STONE FOOTING TO BE ENGINEERED BY SUPERIOR WALL SYSTEMS ENGINEERS FOR SPECIFIC SITE CONDITIONS.

b.FLOOR CONSTRUCTION OF GARAGE TO BE 4" CONCRETE SLAB WITH 6X6-W1.4XW1.4 WELDED WIRE MESH ON CLEAN CRUSHED STONE FOOTING. CRUSHED STONE FOOTING TO BE ENGINEERED BY SUPERIOR WALL SYSTEMS ENGINEERS FOR SPECIFIC SITE CONDITIONS.

c.FLOOR CONSTRUCTION OF FIRST FLOOR OF HOUSE TO BE 3/4" T&G PLYWOOD SUBFLOOR, GLUED AND NAILED TO PRE-FABRICATED 9-1/2" DEEP 210 TJI'S @ 16" O.C.

d.DECKS TO BE FRAMED WITH TREATED 2X6 @ 16" O.C. EXTERIOR GRADE T&G WOOD DECKING AND WOOD FRAMING TO BE AC2 CEDARTONE PREMIUM PRESSURE TREATED PRODUCTS FROM MENARDS.

5. WALLS:

a.CONSTRUCTION OF EXTERIOR WALLS AT HOUSE TO BE VINYL SIDING BY CERTAINTEED, "MONOGRAM" SERIES ON R-6 ZIP SYSTEM R-SHEATHING BY HUBER ON 2X4 STUDS @ 16"

O.C., WITH BATT INSULATION BETWEEN STUDS AND $\frac{1}{2}$ " DRYWALL, WITH LEVEL 4 FINISH, AT INTERIOR FACE. SEE WALL SECTION. TYPICAL STUD TO BE NO. 2 D.F. NOTE "T-STUDS" AT CORNER WINDOWS. COORDINATE WITH ARCHITECT FOR SELECTION OF SIDING COLORS.

b.CONSTRUCTION OF EXTERIOR WALLS AT GARAGE TO BE VINYL SIDING BY CERTAINTEED, "MONOGRAM" SERIES ON HOUSE WRAP ON 70 OSB ON EXPOSED 2X4 STUDS @ 16" O.C., EXCEPT AS INDICATED IN NOTE "H" BELOW. SEE WALL SECTION. COORDINATE WITH ARCHITECT FOR SELECTION OF SIDING COLORS.

c.EXTERIOR TRIM TO BE COMPOSITE LP SMARTSIDE 440 REVERSIBLE TRIM, .625" THICK X 3.5" WIDE, WITH SMOOTH SIDE EXPOSED, FACTORY FINISHED IN WHITE.

d.INTERIOR WALL CONSTRUCTION TO BE 1/2" DRYWALL, WITH LEVEL 4 FINISH, ON 2X4 FRAMING @ 16" O.C., UNLESS OTHERWISE NOTED.

h.INTERIOR FINISH OF GARAGE TO BE NOT LESS THAN 1/2-INCH GYPSUM BOARD OR EQUIVALENT APPLIED ONLY TO THE INTERIOR SIDE OF EXTERIOR WALLS WHERE GARAGE IS LOCATED LESS THAN 3 FEET FROM A DWELLING UNIT ON THE SAME LOT.

i. INTERIOR OF WINDOWS AND DOORS TO BE TRIMMED WITH 3" X 1-1/2" SQUARE-EDGED PAINTED POPLAR.

j. INTERIOR WALL BASE TO BE $\frac{5}{8}$ " X 1-1/2" SQUARE-EDGED PAINTED POPLAR. BASE TO DIE INTO DOOR TRIM.

k.BATHROOM WALLS TO HAVE WATER-RESISTANT GYPSUM BOARD.

I. WALL PAINT "A" TO BE SHERWIN-WILLIAMS SW7028 "INCREDIBLE WHITE", FLAT.

m. TRIM PAINT "A" TO BE SHERWIN-WILLIAMS SW7028 "INCREDIBLE WHITE", EGGSHELL.

n. WALL PAINT "B" TO VARY PER HOUSE. COORDINATE WITH ARCHITECT FOR SELECTION.

o. TRIM PAINT "B" TO VARY PER HOUSE. COORDINATE WITH ARCHITECT FOR SELECTION.

p. SEE WALL SECTION FOR LOCATIONS WHERE SEALANTS ARE REQUIRED TO MEET ENERGY STAR AND DOE ZER REQUIREMENTS. ALL SEALANTS AND CAULKS TO BE NO OR LOW VOC TO MEET INDOOR AIR PLUS REQUIREMENTS.

6. ROOF:

a.ROOF ON HOUSE TO BE ASPHALT SHINGLES BY CERTAINTEED, "LANDMARK" SERIES, ON ROOFING FELT AND 6' ICE AND WATER SHIELD ON 10-1/4" SIP PANEL BY PORTER, INC.,
4/12 SINGLE SLOPE. SHINGLE COLOR TO BE "WEATHERED WOOD". IMPORTANT: ROOF SIP PANELS TO INCLUDE ELECTRICAL CHASES WHERE SHOWN ON PLANS. REFER TO FRAMING
PLANS FOR LOCATION OF DOUBLE 2X10 SPLINES AT SIP EDGES.

b.ROOF ON DETACHED GARAGE TO BE ASPHALT SHINGLES BY CERTAINTEED, "LANDMARK" SERIES, ON ROOFING FELT AND 6' ICE AND WATER SHIELD, ON 2X8 RAFTERS @ 16" O.C., 4/12 SINGLE SLOPE. SHINGLE COLOR TO BE "WEATHERED WOOD". SEE SHEET A1.2 FOR ROOF VENT LOCATIONS.

c.CANOPY ROOF (WHERE SHOWN) TO BE CORRUGATED ZINC ROOFING ON BRACKETS MADE FROM 4X4 AC2 CEDAR TONE PREMIUM PRESSURE TREATED TIMBERS, AVAILABLE AT MENARDS.

d.FASCIA TO BE LP SMARTSIDE 440 SERIES REVERSIBLE TRIM, .625 INCH THICK, SMOOTH SIDE EXPOSED, FACTORY FINISHED IN WHITE.

e.SOFFIT TO BE LP SMARTSIDE 76 SERIES SMOOTH FINISH SOFFIT, .375 INCH THICK, FACTORY FINISHED IN WHITE. INSTALL SOFFIT PANELS WITH 1/4" REVEAL BETWEEN PANELS.
PROVIDE BLACK RAIN-SCREEN GASKET AT REVEALS.

f. CEILINGS TO BE VAULTED AS SHOWN IN BUILDING SECTION. INTERIOR CEILING FINISH TO BE 1/2" DRYWALL, WITH LEVEL 4 FINISH, AT UNDERSIDE OF SIP PANEL.

g.CEILING TO BE PAINTED WITH WALL PAINT "A" TO BE SHERWIN-WILLIAMS SW7022 "ALPACA", FLAT.

h.ALL CEILING PENETRATIONS TO BE SEALED WITH NO OR LOW VOC CAULK OR FOAM, INCLUDING PARTITION WALLS. AT ATTIC, FOAM THE PENETRATIONS FROM THE ATTIC SIDE BEFORE INSULATING.

7. INSULATION:

a.INSULATION TO ACHIEVE AND/OR EXCEED MINIMUM R—VALUE RATINGS (PER MICHIGAN UNIFORM ENERGY CODE) AS FOLLOWS:

b.FOUNDATION WALLS (R= 10/13 MIN): PER MANUFACTURER OF FOUNDATION SYSTEM, R-VALUE = 12.5. AFTER INSTALLATION OF xi SYSTEM BY SUPERIOR, PROVIDE ADDITIONAL R-19 BATT INSULATION WITHIN FOUNDATION SYSTEM CAVITIES AND FINISH WITH 1/2" DRYWALL.

c.EXTERIOR 2X4 FRAMED WALLS (R = 20 OR 13+5 MIN): THOROUGHLY COAT ALL STUD CAVITIES WITH NO OR LOW VOC CAULK AND PROVIDE 3-1/2" BATT INSULATION BETWEEN 2X4 STUDS FOR R-13 RATING. IN ADDITION, AT EXTERIOR FACE, PROVIDE CONTINUOUS INSULATION WITH R-6 ZIP R-SHEATHING BY HUBER FOR R-6.6 RATING; TAPE SEAMS PER MANUFACTURER'S INSTALLATION INSTRUCTIONS. FULLY INSULATE BEHIND ALL WALL INTERSECTIONS.

d.SIP PANEL ROOF (R= 38 MIN): PER MANUFACTURER, R-VALUE OF 10" THICK PANEL IS 42.5. FOR CERTIFICATION, VALUE OF INSULATION TO BE MINIMUM R-38 ACROSS ENTIRE ASSEMBLY.

e.UNHEATED SLAB AT CONDITIONED BASEMENT (R=10, 2 FT MIN): PROVIDE CONTINUOUS 2" RIGID INSULATION BELOW ENTIRE SLAB FOR R-10 RATING.

8. WINDOWS AND DOORS:

OF WINDOW WELL IN FIELD.

a. WINDOWS AND SLIDING DOOR TO BE BY PELLA, ENCOMPASS SERIES, ENERGY STAR, BUILDERS' VINYL; SEE WINDOW/DOOR SCHEDULE FOR WINDOW SIZE AND TYPE. MANUFACTURER TO VERIFY COMPLIANCE WITH EGRESS REQUIREMENTS. EXTERIOR AND INTERIOR OF WINDOW TO BE WHITE. EXTENSION JAMB TO BE PRIMED WOOD. SLIDING DOOR THRESHOLD TO BE WAXIMUM.

b.BASEMENT EGRESS WINDOW TO BE BY PELLA, 250 SERIES, ENERGY STAR; SEE WINDOW/DOOR SCHEDULE. MANUFACTURER TO VERIFY COMPLIANCE WITH EGRESS REQUIREMENTS. EXTERIOR AND INTERIOR OF WINDOW TO BE WHITE. EXTENSION JAMB TO BE PRIMED WOOD.

c.EXTERIOR DOOR AND TRANSOM TO BE BY THERMA-TRU, SMOOTH STAR SERIES S100, ENERGY STAR, FLUSH FACE INSULATED FIBERGLASS, TO BE FIELD-PAINTED AFTER THE FAST BUILD; SEE WINDOW/DOOR SCHEDULE FOR DOOR SIZE. DOOR TO HAVE PEEP-HOLE. HARDWARE AND THRESHOLD TO BE SATIN CHROME. THRESHOLD TO BE BARRIER-FREE.

d.INTERIOR DOORS TO BE 6'-8", FLUSH FACE, CLEAR-COATED MAPLE VENEER MDF SOLID CORE DOORS. SEE PLAN FOR DOOR WIDTHS. DOOR HARDWARE TO BE ADA COMPLIANT AND

SATIN CHROME.

e. PROVIDE CORRUGATED STEEL EGRESS WINDOW WELL AT BASEMENT WHERE SHOWN ON PLANS. PROVIDE LADDER AND COVER TO FIT. FOUNDATION CONTRACTOR TO DETERMINE SIZE

f. OVERHEAD DOOR TO BE FLUSH PANEL FIBERGLASS GARAGE DOOR BY C.H.I., MODEL 2150, PROVIDE ELECTRIC DOOR OPENER. DOOR TO BE FACTORY-FINISHED IN "SANDSTONE"

g.AT DOORS AND WINDOWS, FILL VOIDS WITH CLOSED CELL SPRAY FOAM INSULATION AND SEAL JOINTS WITH NO OR LOW VOC SEALANT.

. MILLWORK:

a.KITCHEN AND BATH CABINET LAYOUTS TO BE PROVIDED BY NEWCRAFT CABINETRY, OR ARCHITECT APPROVED EQUAL. SHOP DRAWINGS TO BE REVIEWED BY ARCHITECT.

b.CABINET DOORS TO BE TUSCANY SERIES, SHAKER STYLE, FACTORY—PAINTED IN "DOVE", OR EQUAL. COORDINATE WITH ARCHITECT FOR SELECTION OF CABINET DOOR PULLS.

c.COUNTERTOPS AT KITCHEN TO BE PLASTIC LAMINATE BY WILSONART, 4886—38, "PEARL SOAPSTONE" (FINE VELVET FINISH).

d. SEAL BACK OF PARTICLE BOARD COUNTERTOPS WITH NO OR LOW VOC SEALER TO TRAP FORMALDEHYDE PRIOR TO APPLYING LAMINATE.

10. FLOOR FINISHES:

a.FLOOR FINISH THROUGHOUT MAIN FLOOR TO BE PREMIUM ENGINEERED VINYL GLUE—LESS FLOATING FLOOR BY SHAW FLOORS, ENDURA 512C PLUS. COORDINATE WITH ARCHITECT FOR COLOR SELECTION.

b.STAIR TREADS TO BE GLUE-DOWN LAMINATE PLANK WITH PRE-ATTACHED STAIR NOSING. COORDINATE WITH ARCHITECT FOR SPECIFIC SELECTION.

c.STAIR RISERS TO BE PAINTED POPLAR. COORDINATE WITH ARCHITECT FOR SPECIFIC PAINT SELECTION. d.AT BASEMENT, FLOOR TO BE EXPOSED CONCRETE.

11. SPECIALTIES:

a.OWNER TO PROVIDE WIRE SHELVING SYSTEM.b.PROVIDE IN—WALL BLOCKING AT LOCATIONS OF FUTURE GRAB BARS.

2 FLECTRICAL

a. LIGHT FIXTURES TO BE PROVIDED BY OWNER PRIOR TO CONSTRUCTION. ELECTRICAL CONTRACTOR TO INSTALL ALL FIXTURES, AS WELL AS INTERIOR AND EXTERIOR OUTLETS, CIRCUITING, SWITCH, COMPUTER, AND TELEVISION CABLE CONNECTIONS.

b.AT LIVING, INSTALL:

1.CEILING-MOUNTED JUNO SLIMFORM FIXTURES, 7" DIAMETER, 3000 K. COORDINATE WITH ARCHITECT FOR FINISH AND ACCESSORY SELECTION. ELECTRICAL CHASE TO BE PROVIDED

IN SIP PANELS TO ACCOMMODATE WIRING.

c.AT DINING AREA, INSTALL:

1.COMBINATION CEILING FAN/LIGHT BY MINKA AIRE: "ZEN", 52" DIAMETER, BRUSHED NICKEL, ENERGY STAR. ELECTRICAL CHASE TO BE PROVIDED IN SIP PANELS TO ACCOMMODATE WIRING.

d.AT KITCHEN, INSTALL:
1.UNDERCABINET LED TAPE LIGHTS. 3000K COLOR TEMP.

2.CEILING-MOUNTED JUNO SLIMFORM FIXTURES, 7" DIAMETER, 3000 K. COORDINATE WITH ARCHITECT FOR FINISH AND ACCESSORY SELECTION. ELECTRICAL CHASE TO BE PROVIDED IN SIP PANELS TO ACCOMMODATE WIRING.

3.WALL-MOUNTED SCONCE BY PROGRESS LIGHTING P5674-82/30K METALLIC GRAY LED CYLINDER DOWN LIGHT e.AT BATH, INSTALL:

1.18" BRINK SLIM BATH BAR, BRUSHED ALUMINUM, 3000 K, LED WALL-MOUNTED VANITY LIGHT FIXTURE.

2.COMBINATION LIGHT/EXHAUST FAN BY PANASONIC, FV0511VKL1. ROUTE EXHAUST THROUGH ROOF. INCLUDE OPTIONAL CONDENSATION SENSOR: FV-CSVK1. f.AT BEDROOM CORRIDOR, INSTALL:

1.WALL-MOUNTED FIXTURE BY JU NO, SLIMFORM, 5" DIAMETER, 3000K. COORDINATE WITH ARCHITECT FOR FINISH AND ACCESSORY SELECTION.

g.AT BEDROOMS, INSTALL:

1.SWITCH OUTLET FOR LAMP ON BED WALL.

2.WALL-MOUNTED FIXTURE BY JUNO, SLIMFORM, 5" DIAMETER, 3000K. COORDINATE WITH ARCHITECT FOR FINISH AND ACCESSORY SELECTION.
3.CEILING MOUNTED FIXTURE AT CLOSETS AND BEDROOM CORRIDOR TO BE BY JUNO, SLIMFORM, 5" DIAMETER, 3000K. COORDINATE WITH ARCHITECT FOR FINISH AND ACCESSORY

h.AT BASEMENT, INSTALL PORCELAIN SOCKETS WITH LED LAMPS.

i.AT EXTERIOR OF FRONT ENTRY AND AT EXTERIOR OF SLIDING DOOR, INSTALL:

1.WALL-MOUNTED SCONCE BY PROGRESS LIGHTING P5674-82/30K METALLIC GRAY LED CYLINDER DOWN LIGHT

i.ALL FIXTURES TO BE LED AND MUST BE ENERGY STAR-QUALIFIED.

j.PROVIDE WIRING CHASE, HARNESS POINT, AND CLEARANCE SPACE AT THE BREAKER PANEL FOR FUTURE SOLAR INSTALLATION.

k.RECEPTACLE OUTLETS AND LIGHT CONTROLS TO BE LOCATED 15 INCHES MINIMUM AND 48 INCHES MAXIMUM ABOVE THE FLOOR, TO MEET VISIBILITY REQUIREMENTS.

I.REFER TO MECHANICAL DRAWINGS FOR METER LOCATIONS.

13. HVAC:

a.HVAC SYSTEM TO BE SMALL DUCT SYSTEM AS SHOWN ON MECHANICAL DRAWINGS.

b.PROGRAMMABLE THERMOSTATS ARE REQUIRED.

c.INDOOR AIR QUALITY CERTIFIED UNDER EPA INDOOR AIR PLUS

d.PROVIDE ENERGY RECOVERY VENTILATOR TO PROVIDE REQUIRED FRESH AIR TO HOUSE. MODEL NO. TO BE BROAN ERV140ECM.

e.DUCT SHAFTS, UTILITY PENETRATIONS AND FLUE SHAFTS OPENING TO THE EXTERIOR SHALL BE SEALED.

f. SEE EXTERIOR ELEVATIONS. SHEET A3.1. FOR LOCATION OF EXHAUST VENTS.

14. PLUMBING:

a.PLUMBING FIXTURES TO BE PROVIDED BY OWNER PRIOR TO CONSTRUCTION. PLUMBING CONTRACTOR TO INSTALL THE FOLLOWING.

1.ALL FIXTURES TO BE LOW-FLOW (LAV - 0.5 GPM, SHOWER - 1.5 GPM, KITCHEN SINK - 1.5 GPM, TOILET - 1.2 GPF)

2.WC: NIAGARA CONSERVATION N7717N7714, CENTOCO TRIM MODEL 600. CONTRACTOR TO VERIFY IF 10" OR 12" ROUGH-IN IS REQUIRED.

3.BATHROOM VANITY TOP AND BOWL: SINGLE HOLE, ADA COMPLIANT WALL-MOUNTED SINK BY TECLA MARO1011. 4.BATHROOM VANITY FAUCET: ADA-COMPLIANT DELTA TRINSIC 599LF-HGM-PP LEVER FAUCET.

5.KITCHEN SINK: DAYTON DSE23322; STAINLESS STEEL, DOUBLE BOWL, TOP MOUNT SINK, 3 FAUCET HOLE, DEARBORN BRASS 15 SNAP-N-TITE LOCKING CUP SINK BASKET STRAINER.

6.KITCHEN FAUCET: DELTA 340-WE-DST FAUCET; 1.0GPM (WITH AERATOR FLOW RESTRICTOR INSERT)

7.SHOWER: AQUATIC, MODELI # 727149389703, WHITE 8.SHOWER FAUCET: ADA COMPLIANT FAUCET TO BE XXX.

9..BATH TUB: NOT USED
10.BATH TUB FAUCET: NOT USED

11.HOSE—BIBB: ZURN Z1345, NON—FREEZE, ANTI—SIPHON, AUTOMATIC DRAINING, CHROME FINISH.

12.CITY WATER AND SEWER ARE LOCATED IN EAST MICHIGAN AVENUE AND FORESMAN AVENUE. INCLUDE TAP FEE AND COST OF NEW LEAD TO HOUSE.

13.WATER HEATER TO BE ELECTRIC AND MUST MEET EFFICIENCY LEVELS FOUND IN SECTION 3.3 OF THE EPA WATERSENSE SINGLE—FAMILY NEW HOME SPECIFICATION AND BE ENERGY STAR—QUALIFIED. LOCATE WATER HEATER SO THAT THE HOT WATER DISTRIBUTION SYSTEM SHALL STORE NO MORE THAN .5 GALLONS BETWEEN HOT WATER SOURCE AND HOT WATER FIXTURE. TO MINIMIZE WATER WASTED WHILE WAITING FOR HOT WATER, THE HOT WATER DISTRIBUTION SYSTEM SHALL STORE NO MORE THAN

0.5 GALLONS (1.9 LITERS) OF WATER IN ANY PIPING/MANIFOLD BETWEEN THE HOT WATER SOURCE AND ANY HOT WATER FIXTURE.

a. GRADING OF SITE AND CONSTRUCTION OF RETAINING WALLS BY OTHERS; SITE DRAWINGS INCLUDED FOR INFORMATION ONLY.

14.IF SUMP CROCK IS REQUIRED, CROCK MUST BE SEALED WITH "RADON-READY" LID.

15.PROVIDE ** HOME RUNS FROM FACH FIXTURE TO WATER HEATER PROVIDE ** INCH N

15.PROVIDE 1 HOME RUNS FROM EACH FIXTURE TO WATER HEATER. PROVIDE 1 INCH MANIFOLD FOR 3-FEET MAXIMUM FROM THE WATER HEATER.

b.INCLUDE COST FOR UTILITY INSTALLATION, FLAT WORK AND LANDSCAPING;

16. APPLIANCES (TO BE PROVIDED BY BUILDER):
a.ENERGY STAR-RATED, ADA COMPLIANT REFRIGERATOR TO BE BY GE, MODEL #: GTE16GSHSS, 28" WIDE X 64-1/4" HIGH X 29-1/2" DEEP, 15.3 CF, STAINLESS STEEL FINISH.

b.ENERGY STAR DISHWASHER TO BE BY GE, MODEL # GDF520PGJ/PSJSS, STAINLESS STEEL FINISH.

c.ENERGY STAR COMBINATION MICROWAVE/HOOD TO BE BY GE, MODEL #: JVM3160RFSS OVER-THE-RANGE MICROWAVE OVEN, STAINLESS STEEL FINISH. TAKE CARE TO ALIGN EXHAUST WITH SPACE BETWEEN STUDS FOR HORIZONTAL EXHAUST TO EXTERIOR.

d.ENERGY STAR AND ADA COMPLIANT ELECTRIC RANGE TO BE BY GE, MODEL # JB450RKSS, FREE-STANDING, STAINLESS STEEL FINISH.

e.GARBAGE DISPOSER TO BE BY GE, MODEL # GFC530V, 1/2 HORSEPOWER CONTINUOUS-FEED DISPOSER.

f. ENERGY STAR AND ADA COMPLIANT VENTLESS COMBINATION WASHER/DRYER TO BE BY LG WM3997HWA, 27" W X 30" DEEP.

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GENERAL NOTES


18016

project number

drawing date
7.3.18

sheet number

A1.0

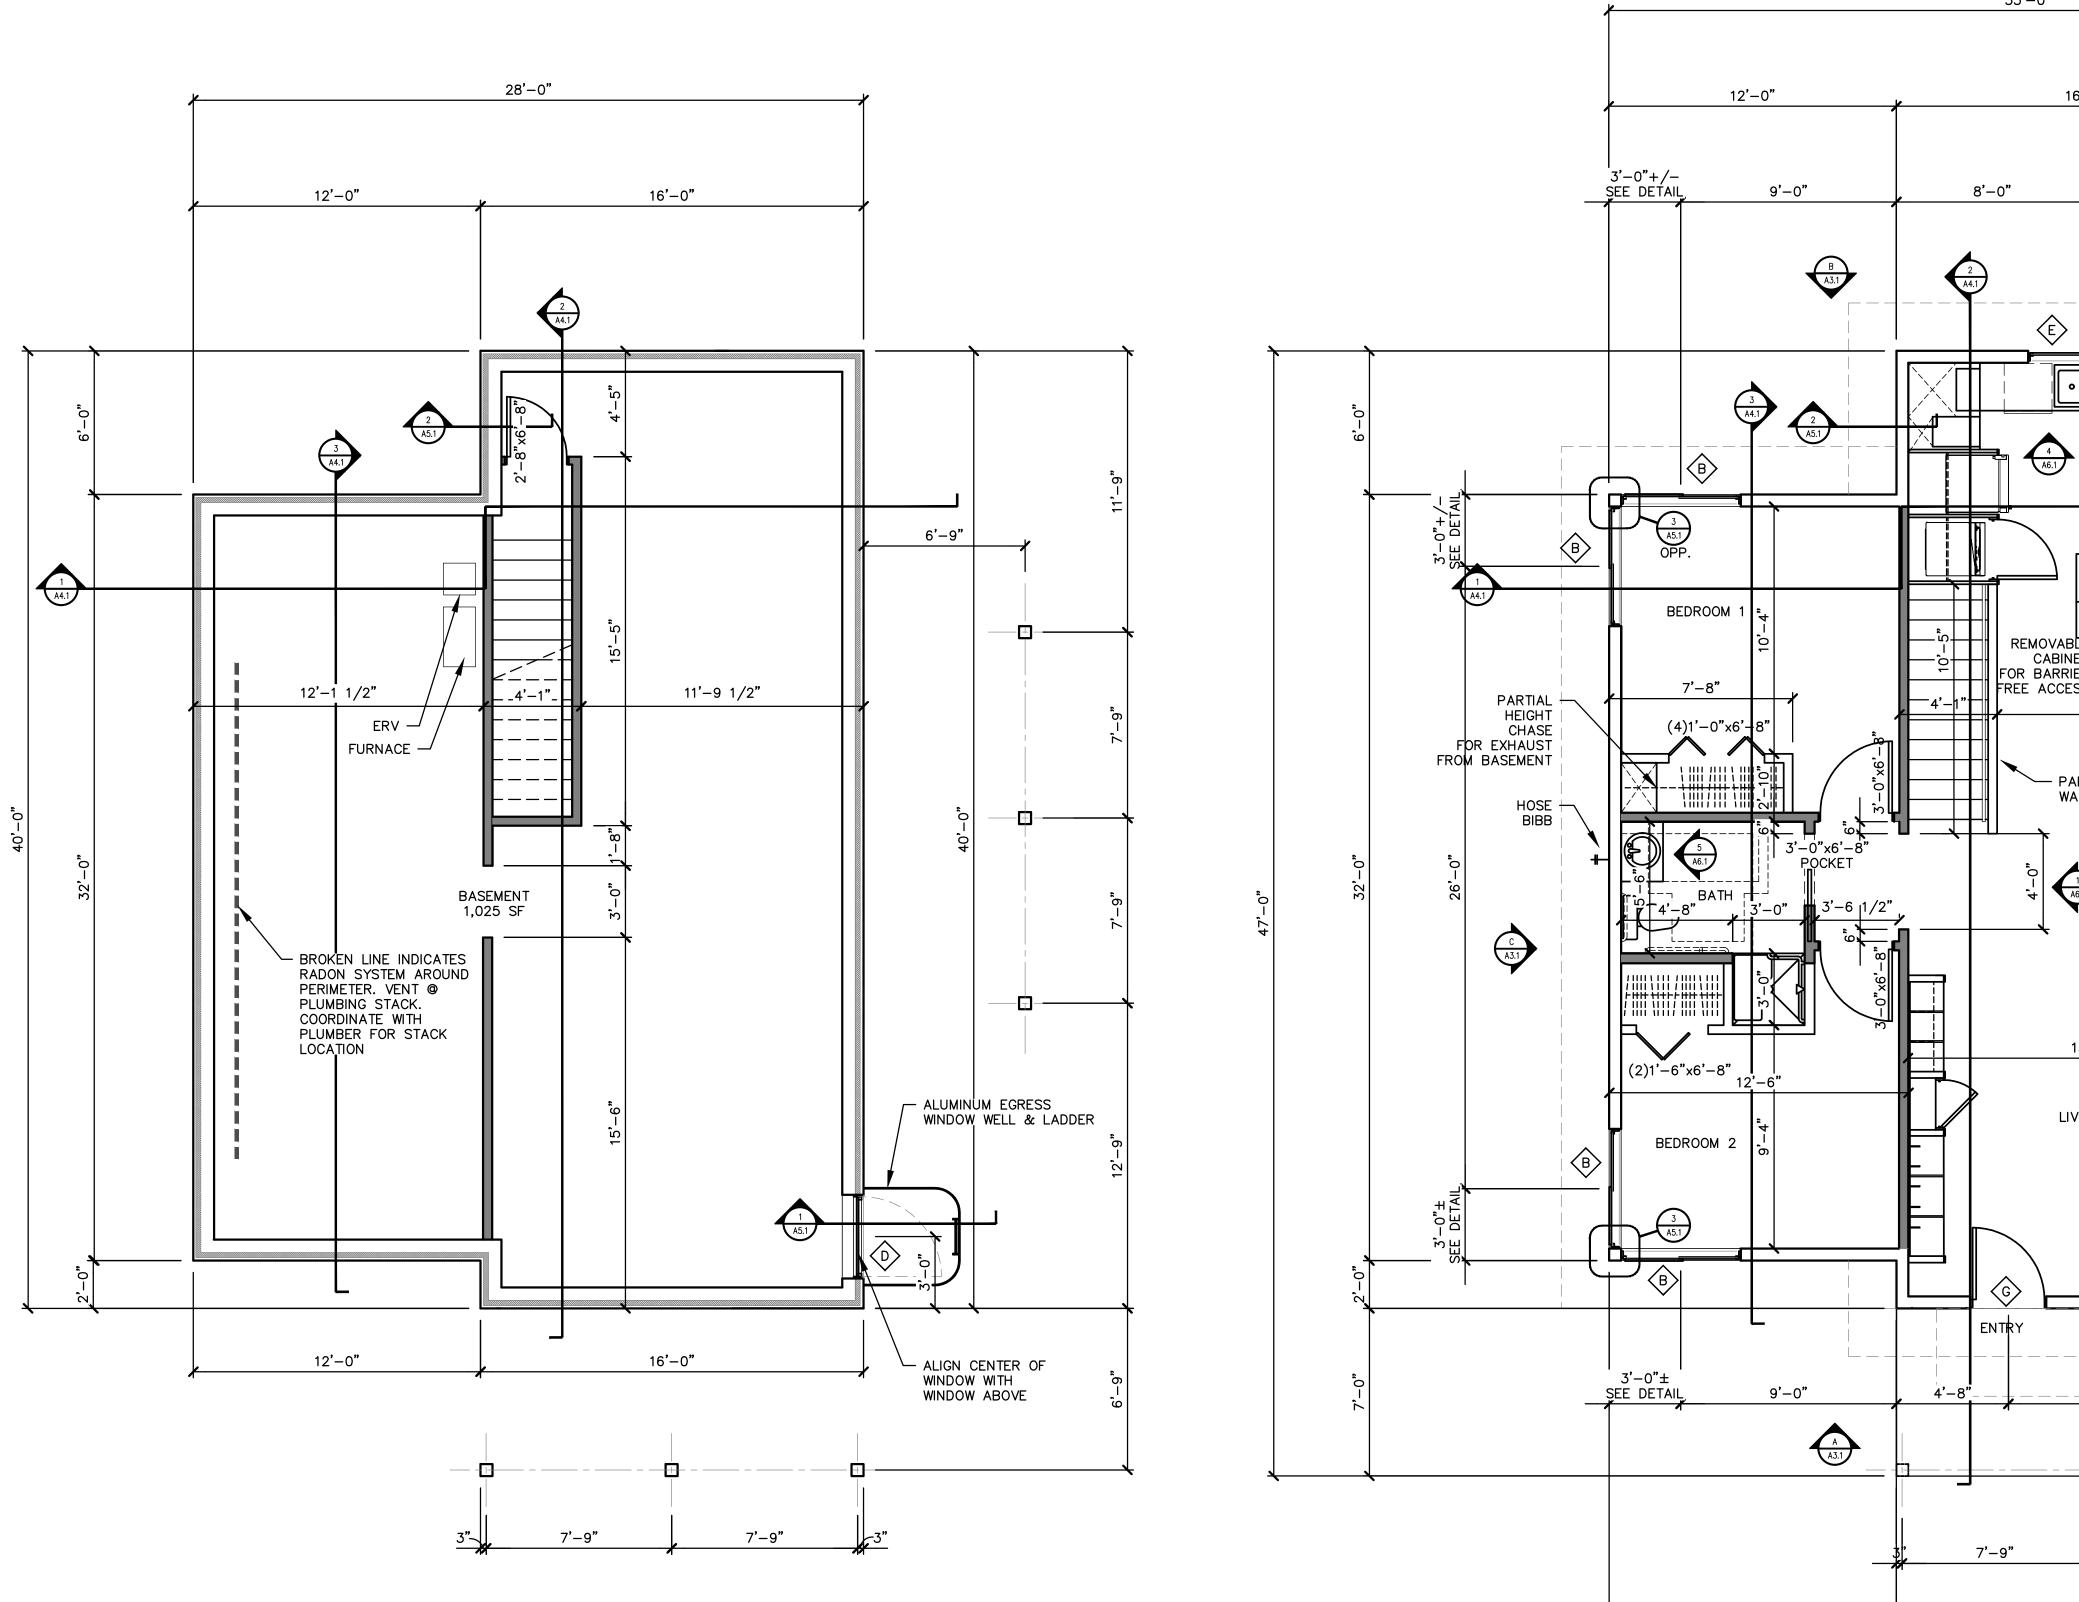

35'-0" 16**'**-0" 7'-0" 8'-0" EDGE OF ROOF HOSE BIBB KITCHEN REMOVABLE CABINET
FOR BARRIER
FREE ACCESS
11'-9 1/2" ➤ PARTIAL HEIGHT WALL 1 A6.1 A3.1 6'-7 1/2" 15'-6" EGRESS WELL BELOW 3'-0"+/-SEE DETAIL 7**'**–9"

MAIN LEVEL 978 SF

16'-0"

7'-0"

12'-0"



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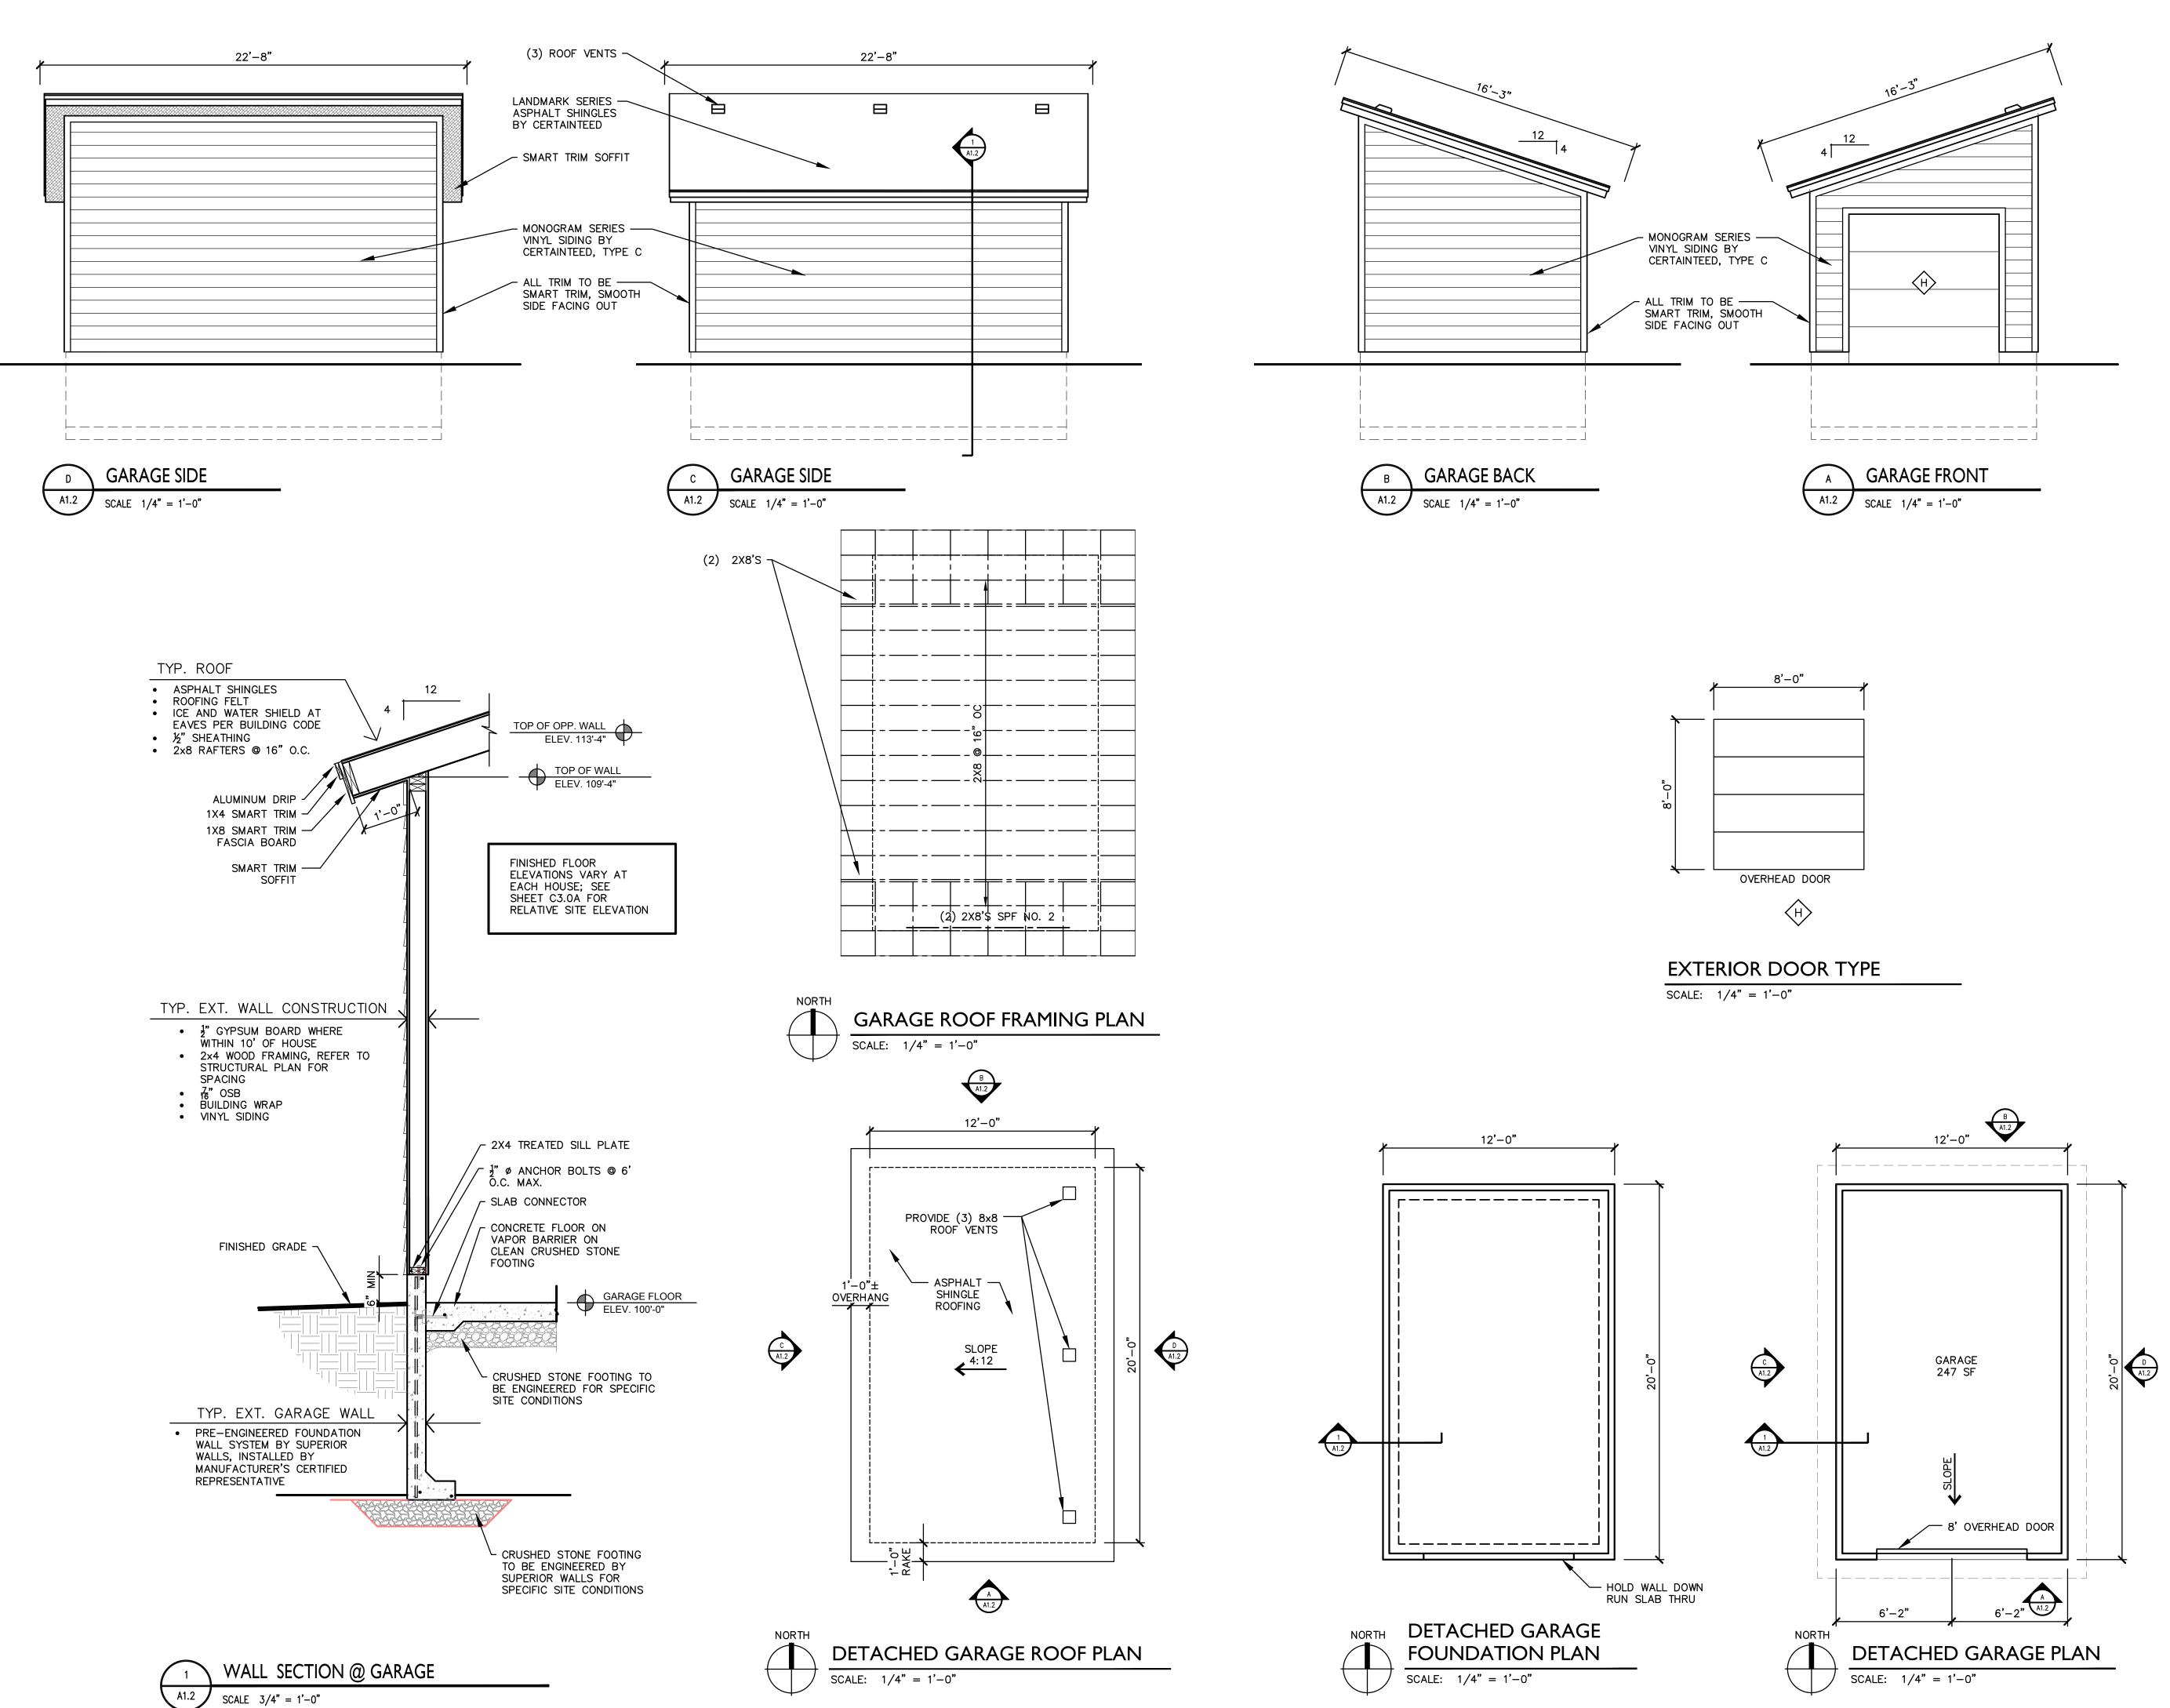
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Eastside Gateway Pro

2 Bedrooms


sheet name
GARAGE PLANS,
ELEVATIONS & DETAILS


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A1.2

sheet number



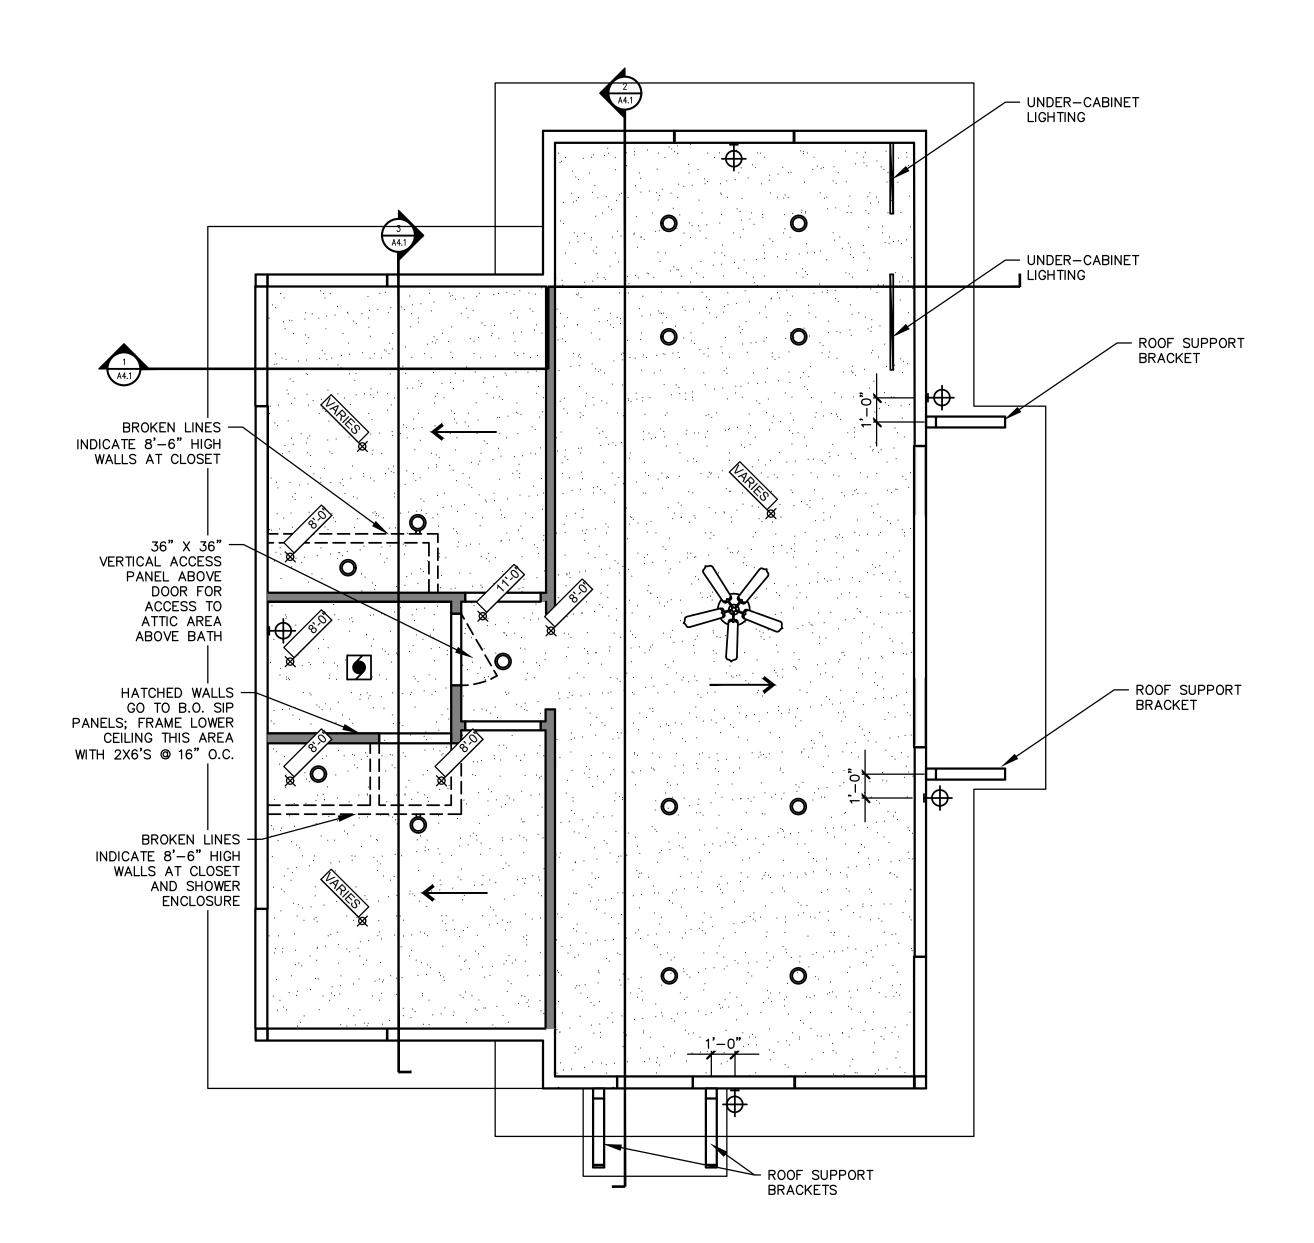

REFLECTED CEILING/ LIGHTING PLAN

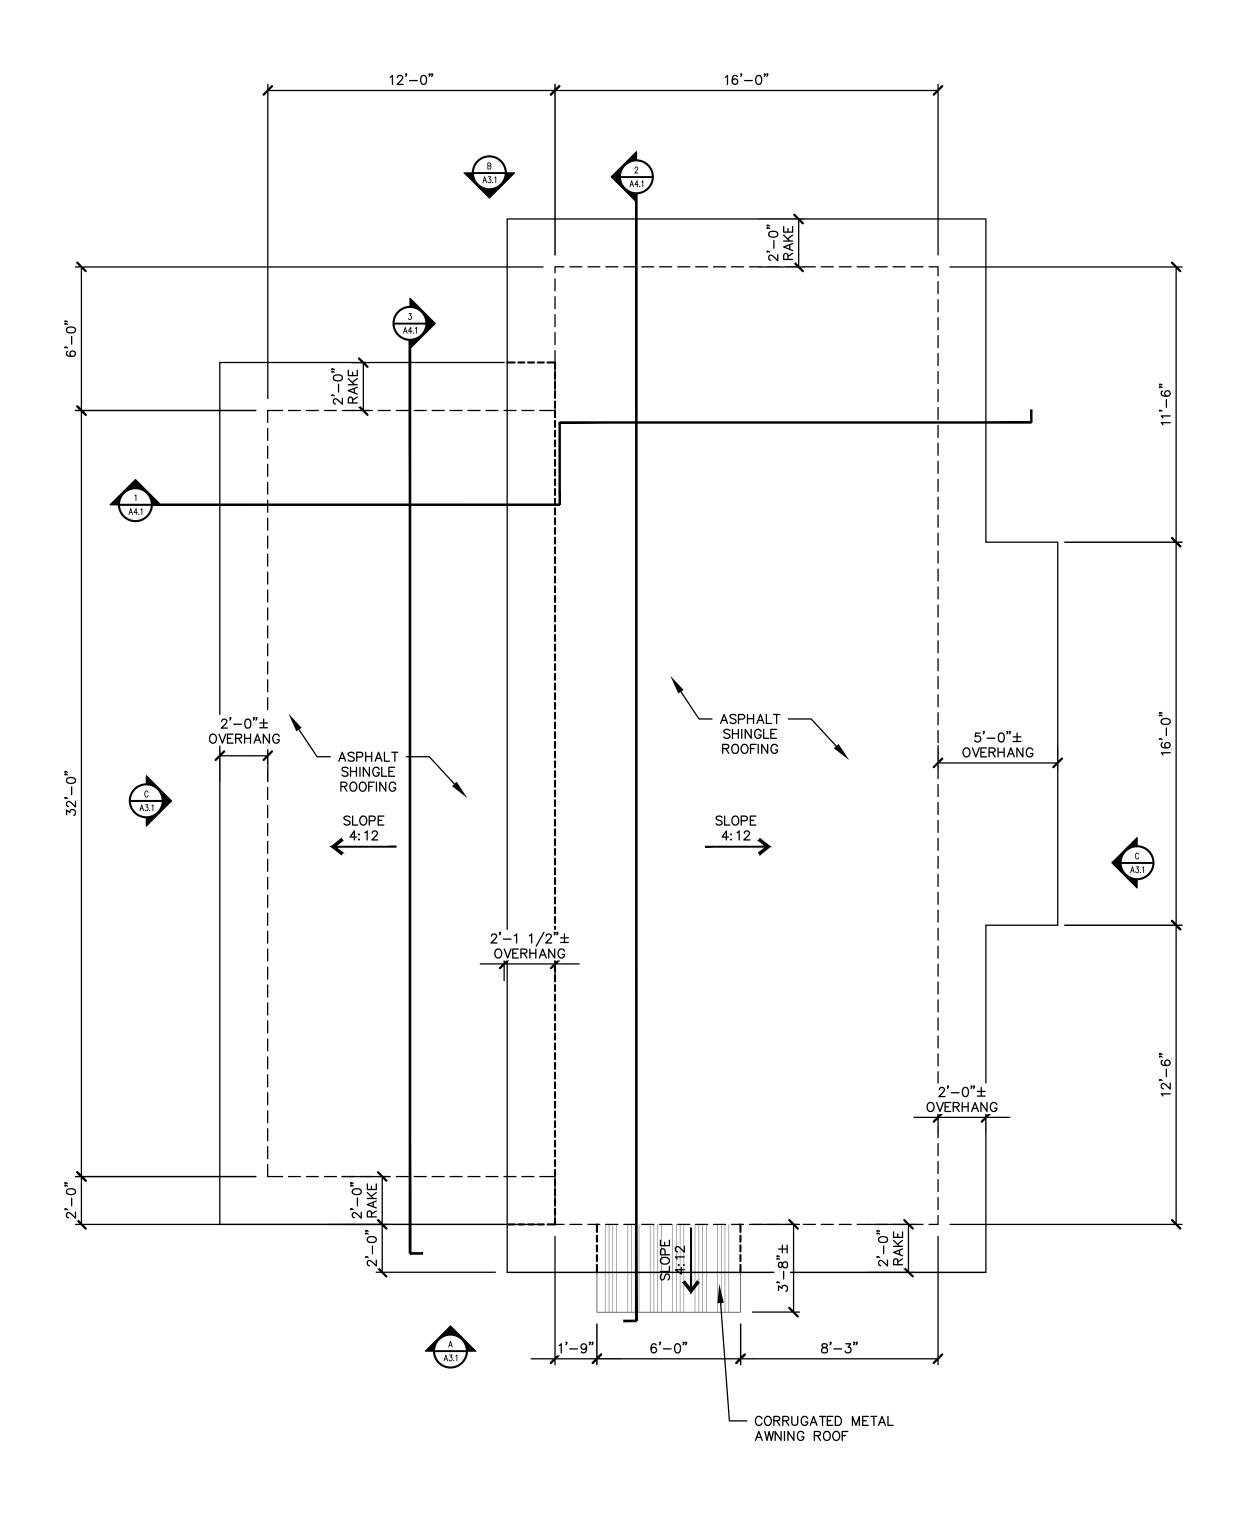SCALE: 1/4" = 1'-0"



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Eastside Gateway Project 2 Bedrooms

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REFLECTED CEILING &

ROOF PLAN


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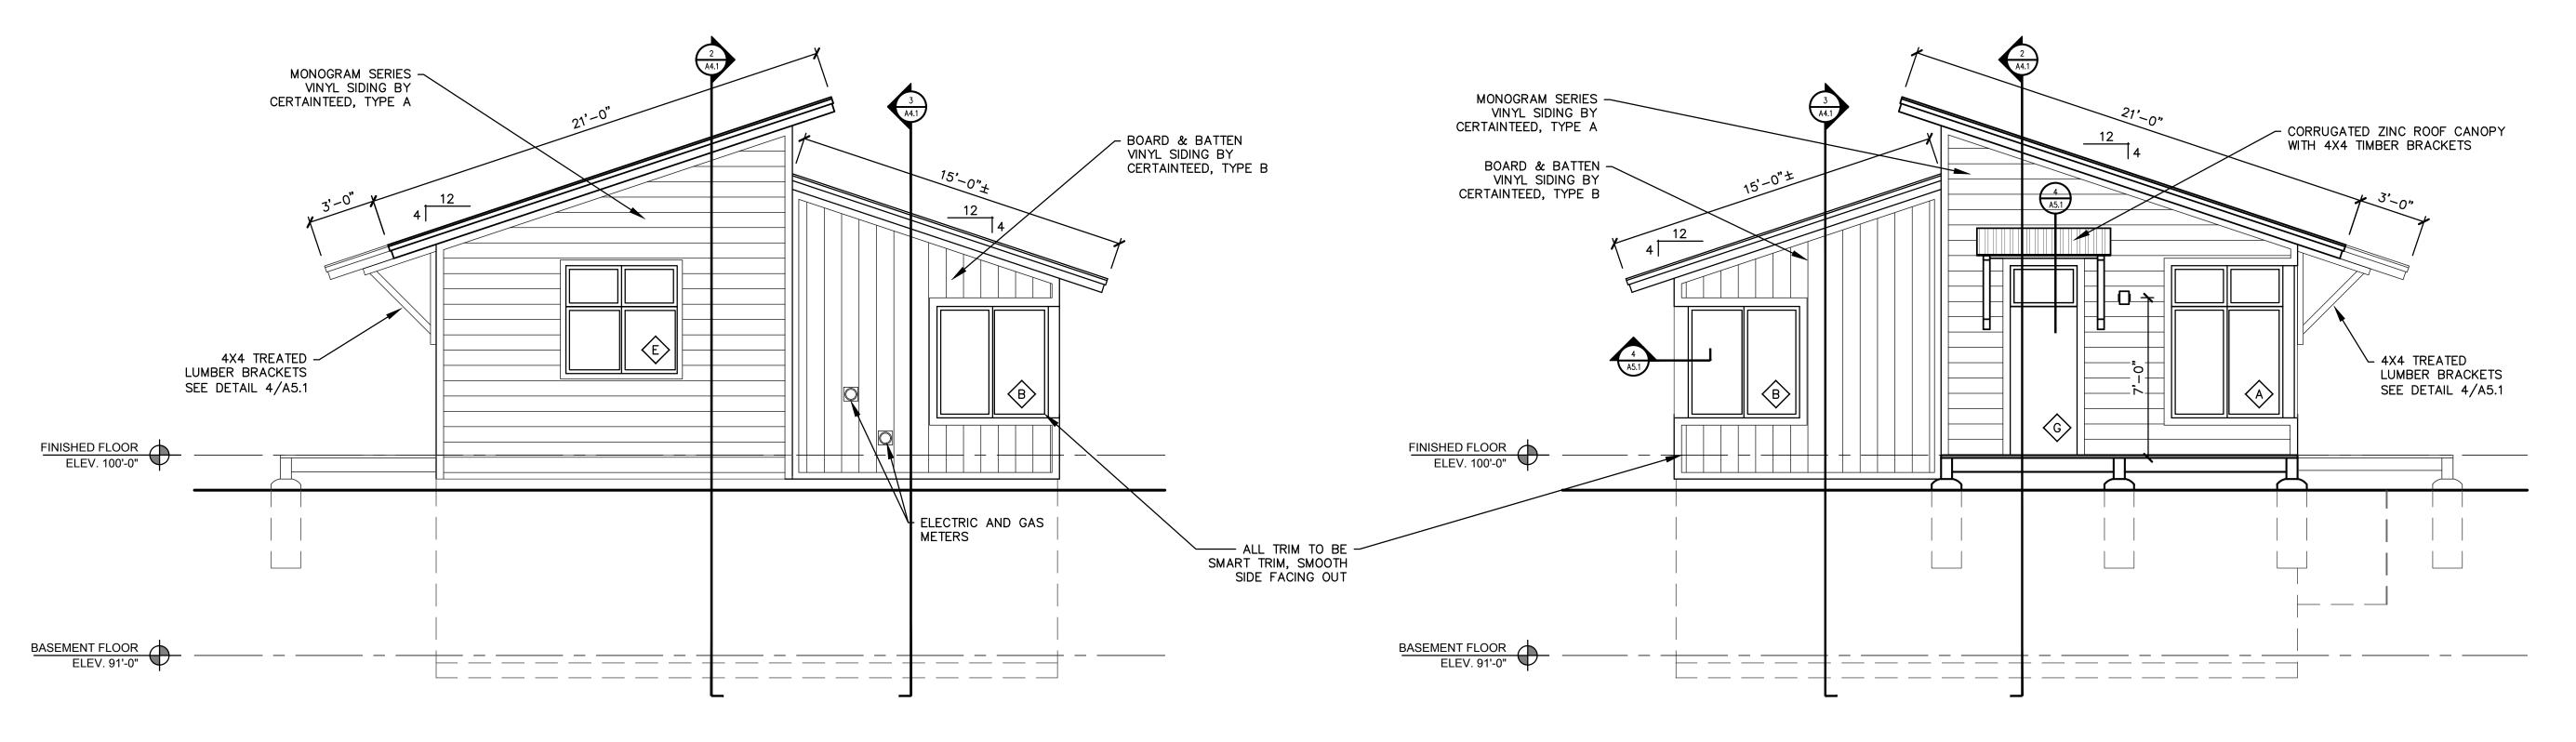
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A2.1





BACK ELEVATION

SCALE 1/4" = 1'-0"

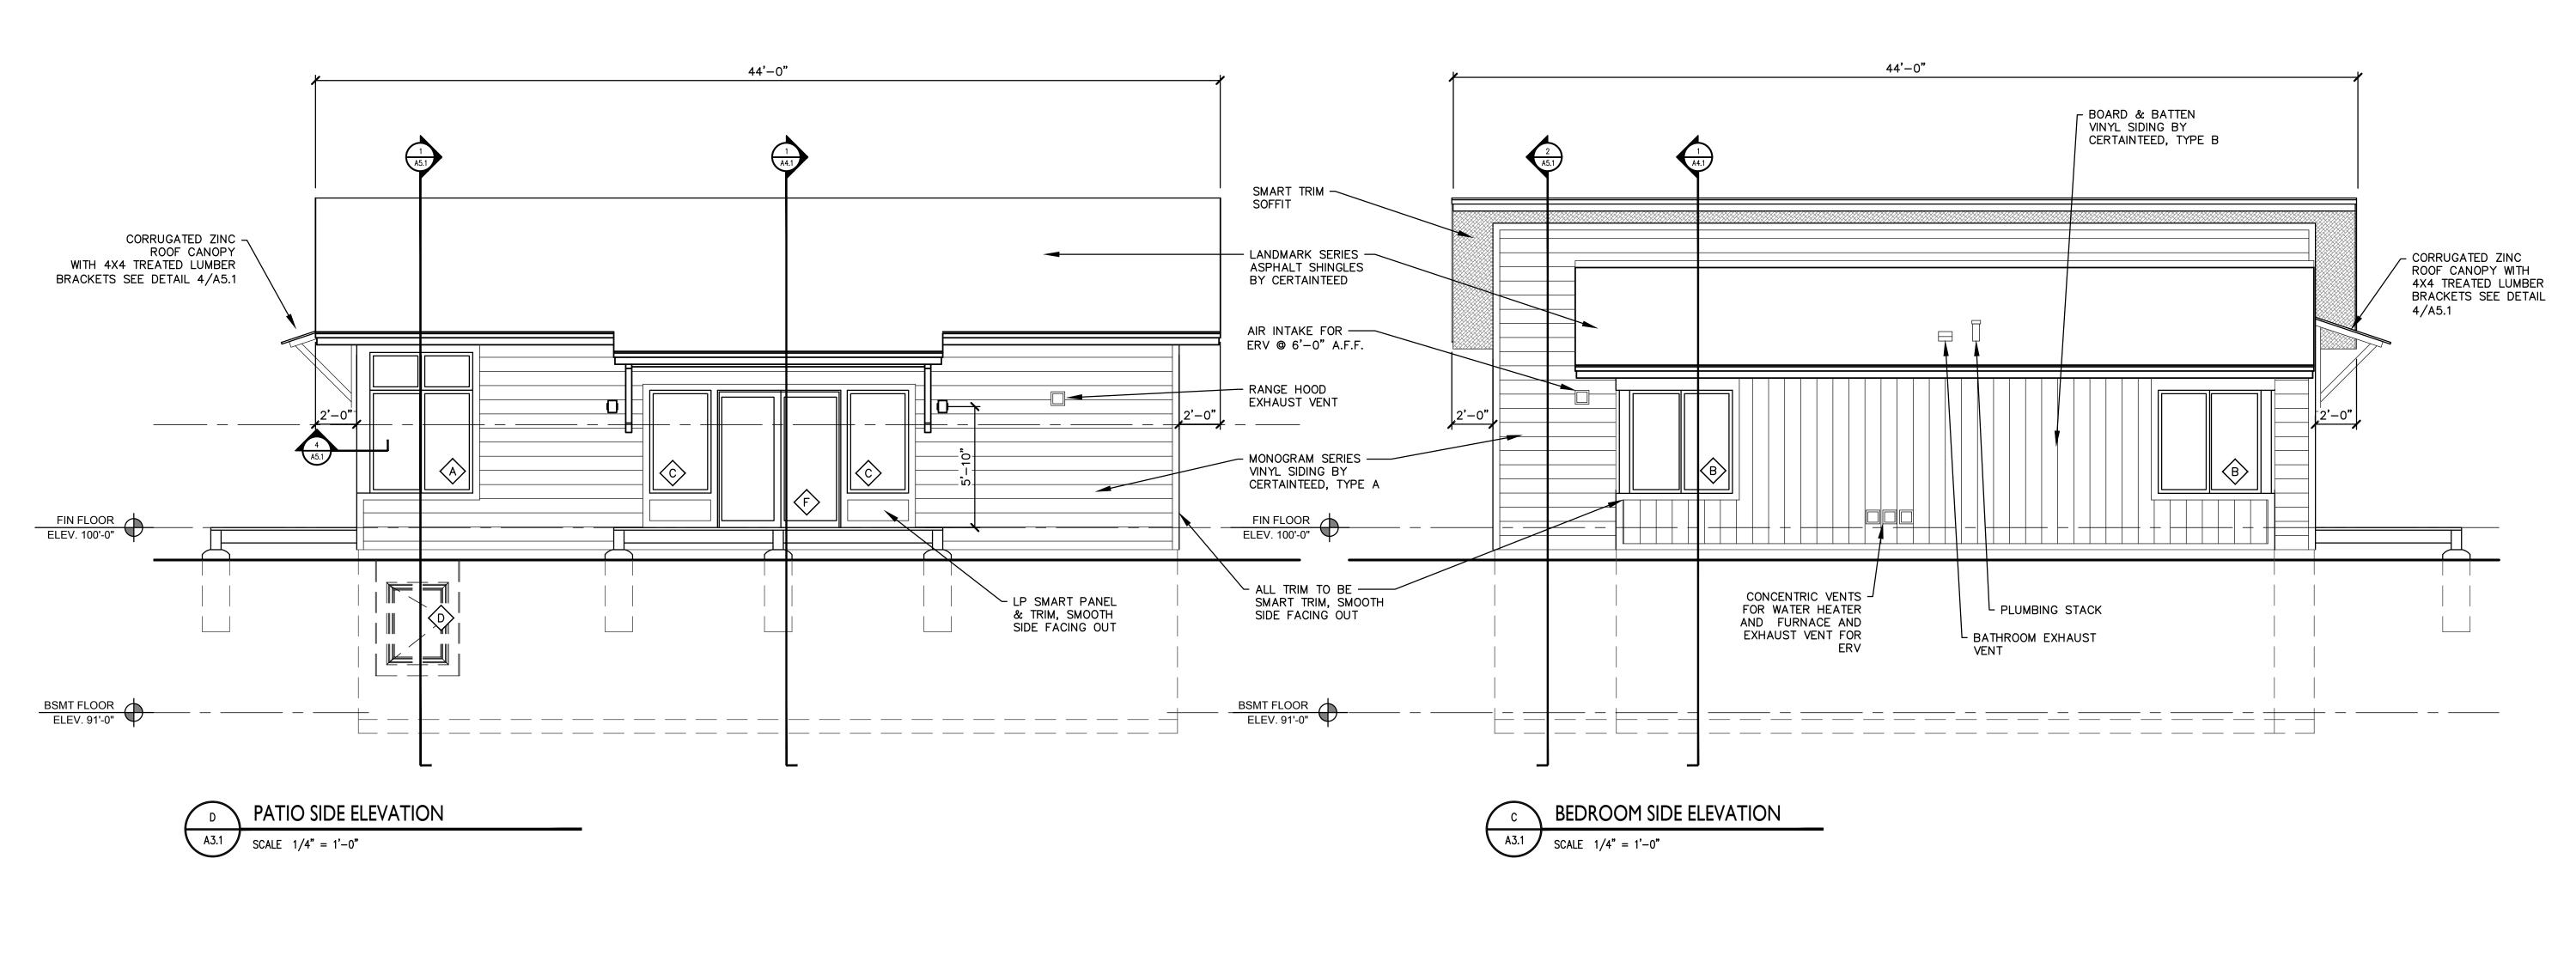A FRONT ELEVATION

SCALE 1/4" = 1'-0"

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7 Redrooms

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EXTERIOR ELEVATIONS


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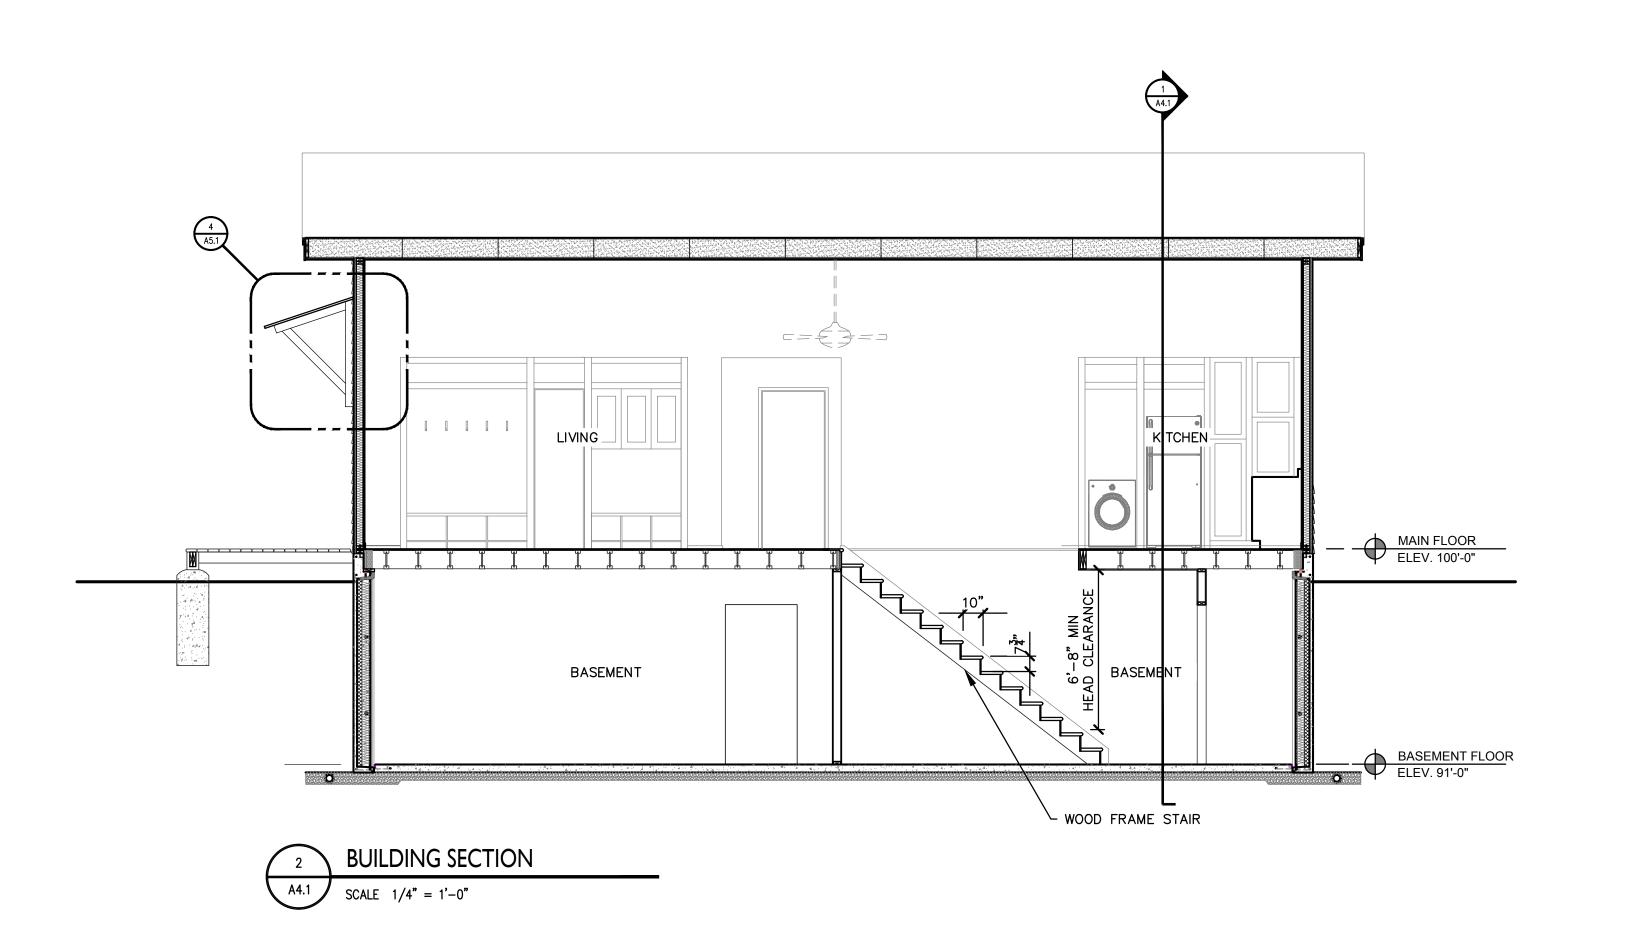
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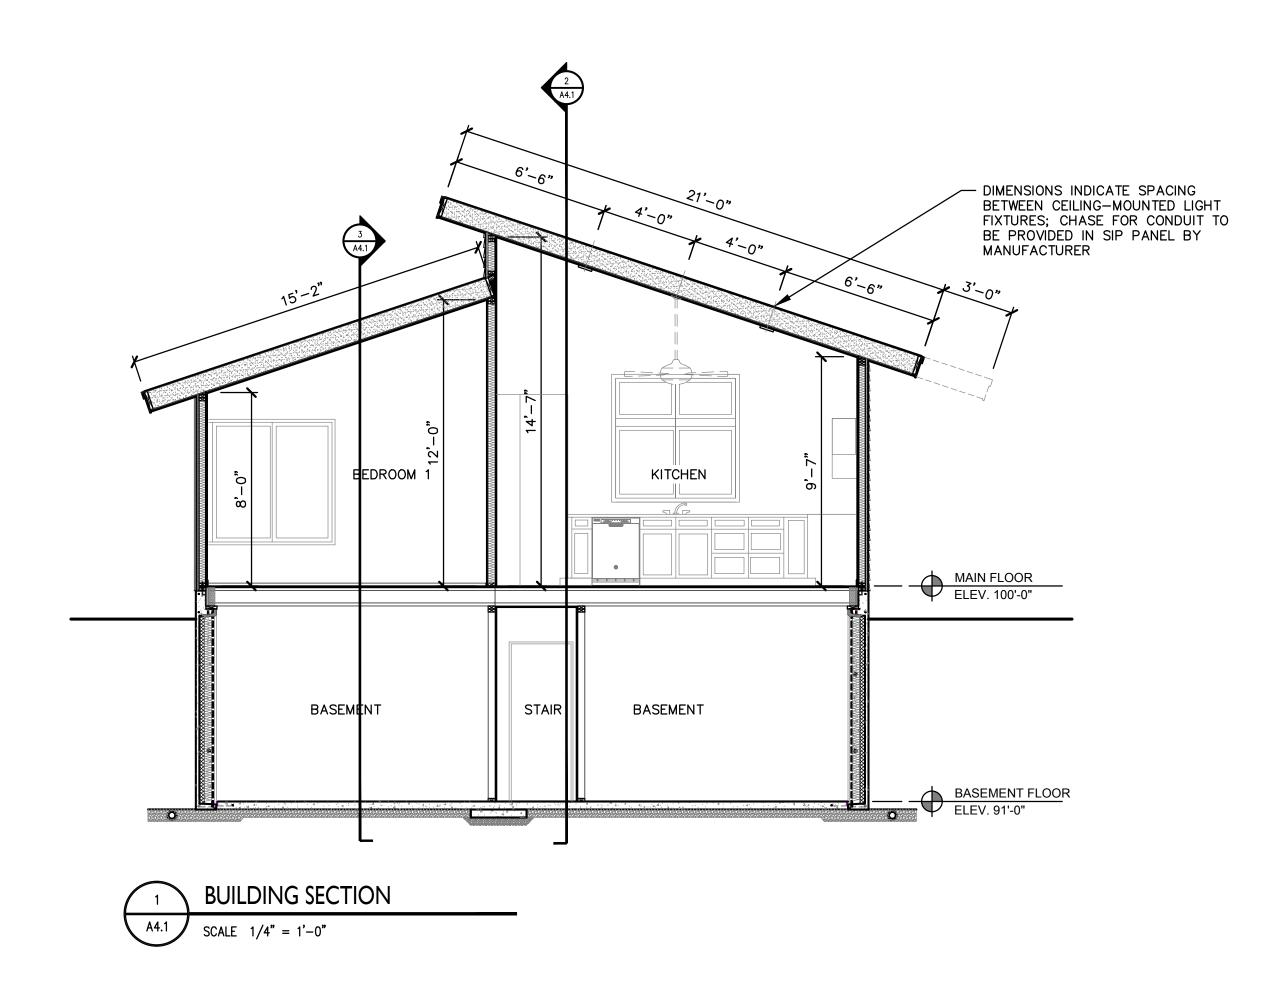
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de Gateway Project 2 Bedrooms

East Michigan Ave. Between

sheet name
BUILDING SECTIONS


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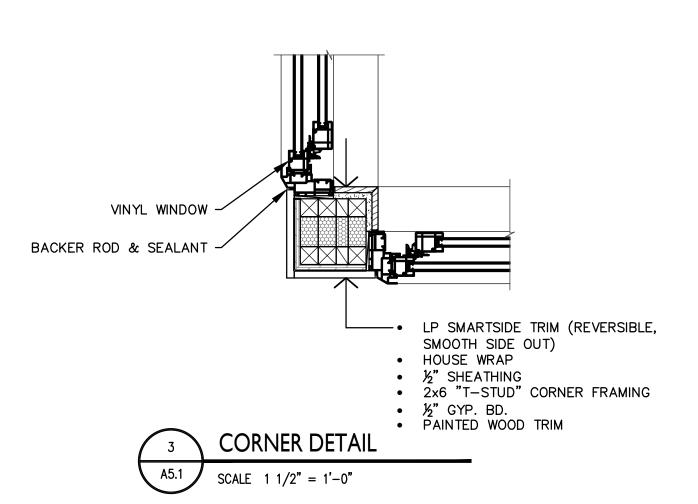
A4.

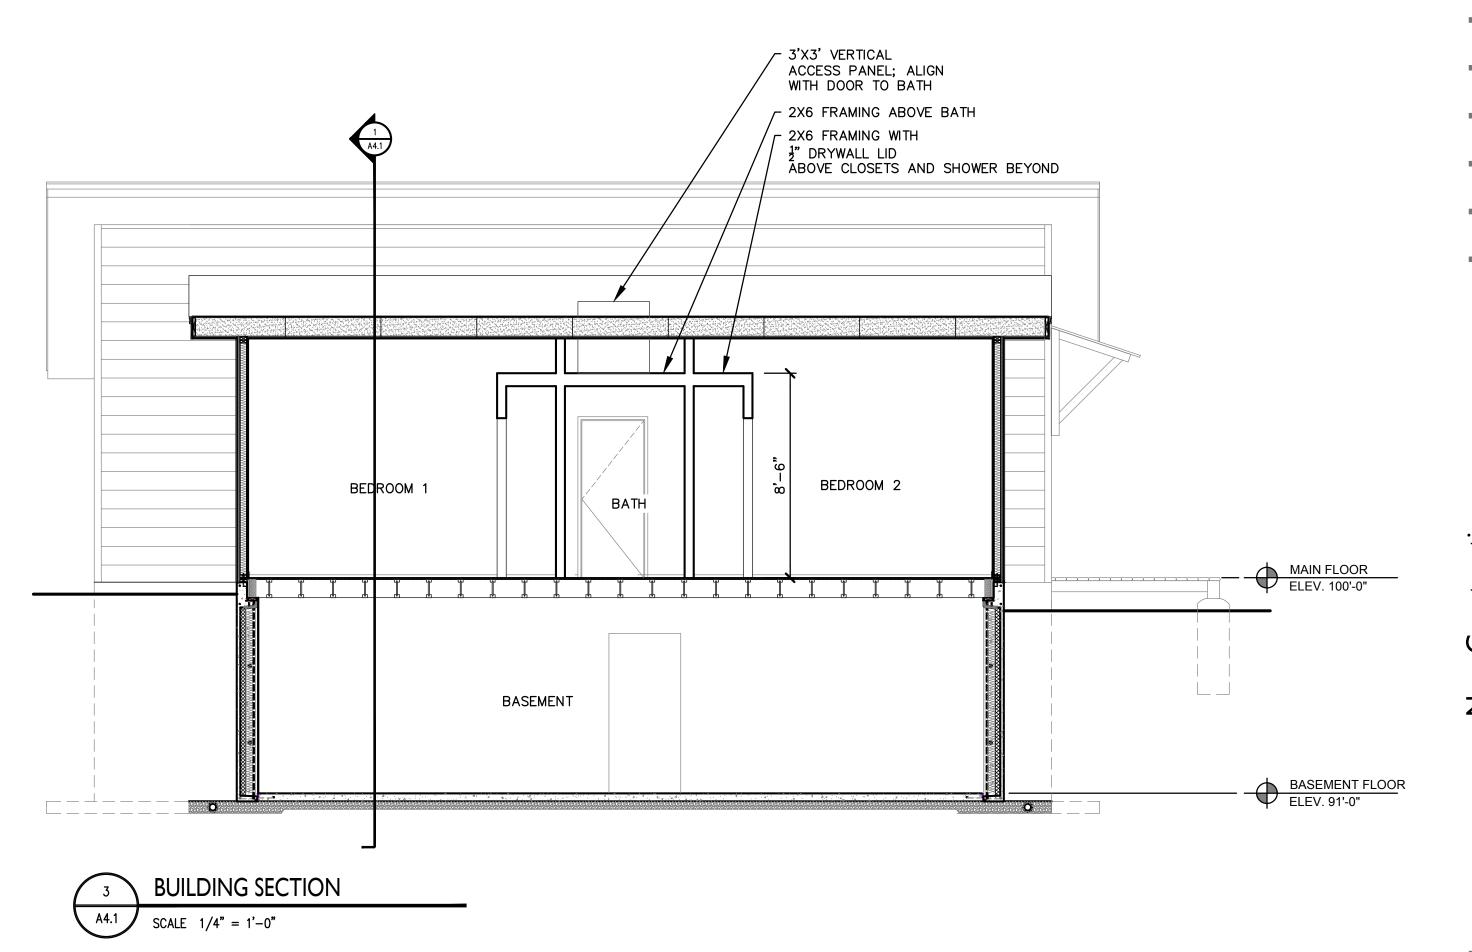


NOTE: PORCH BRACKETS NEAR SLIDING DOOR SIMILAR MINUS CORRUGATED METAL ROOF

FRONT DOOR BRACKET DETAIL

SCALE 3/4" = 1'-0"

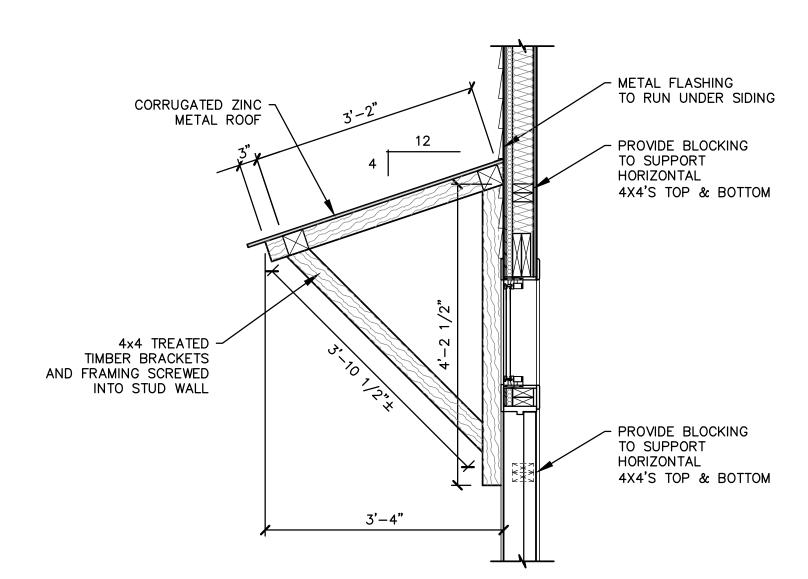

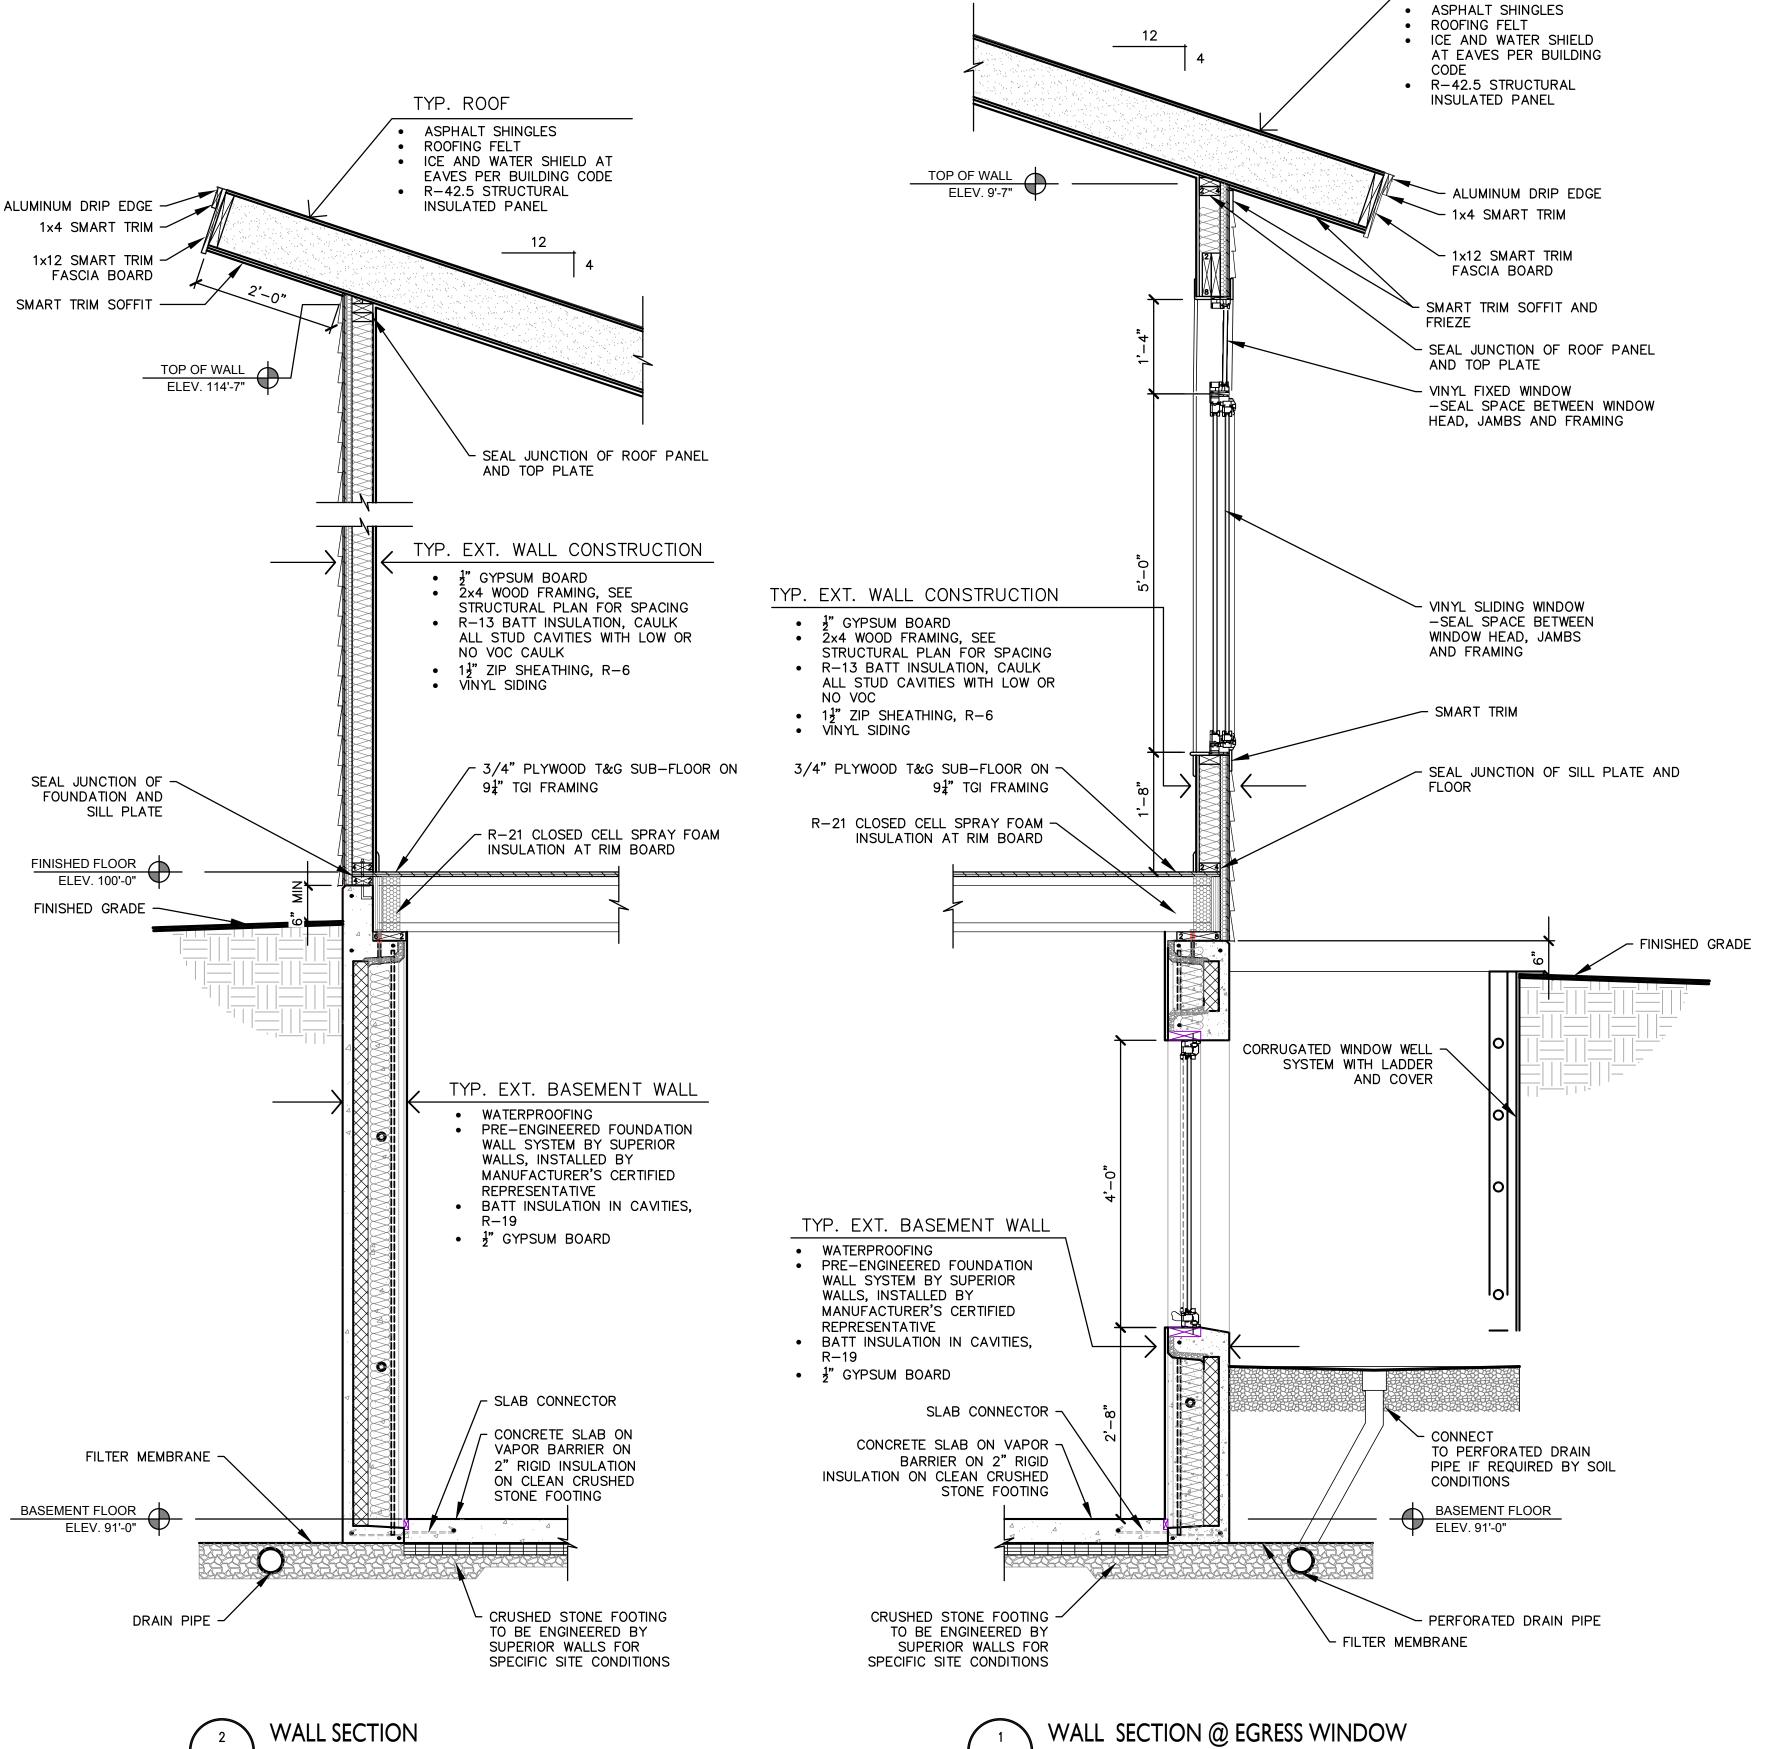

SCALE 3/4" = 1'-0"

SCALE 3/4" = 1'-0"

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TYP. ROOF

Eastside Gateway Project

2 Bedrooms

sheet name
BUILDING SECTIONS &
WALL SECTION


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A5.



3'-2-1/2"+/-RO

FIXED

FLUSH FIBERGLASS

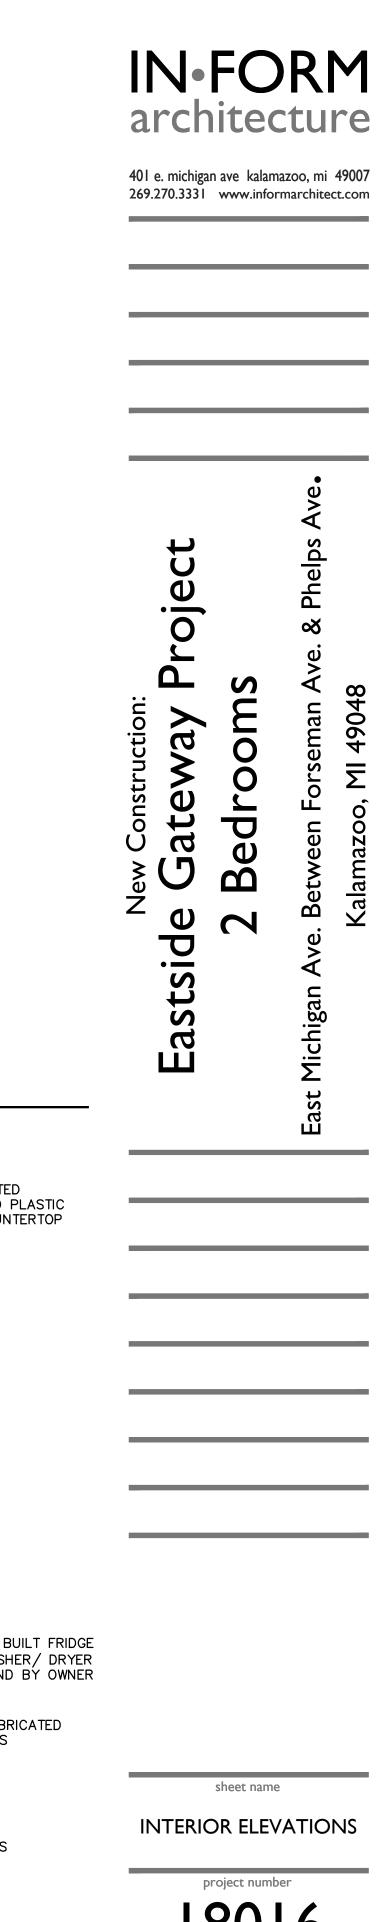
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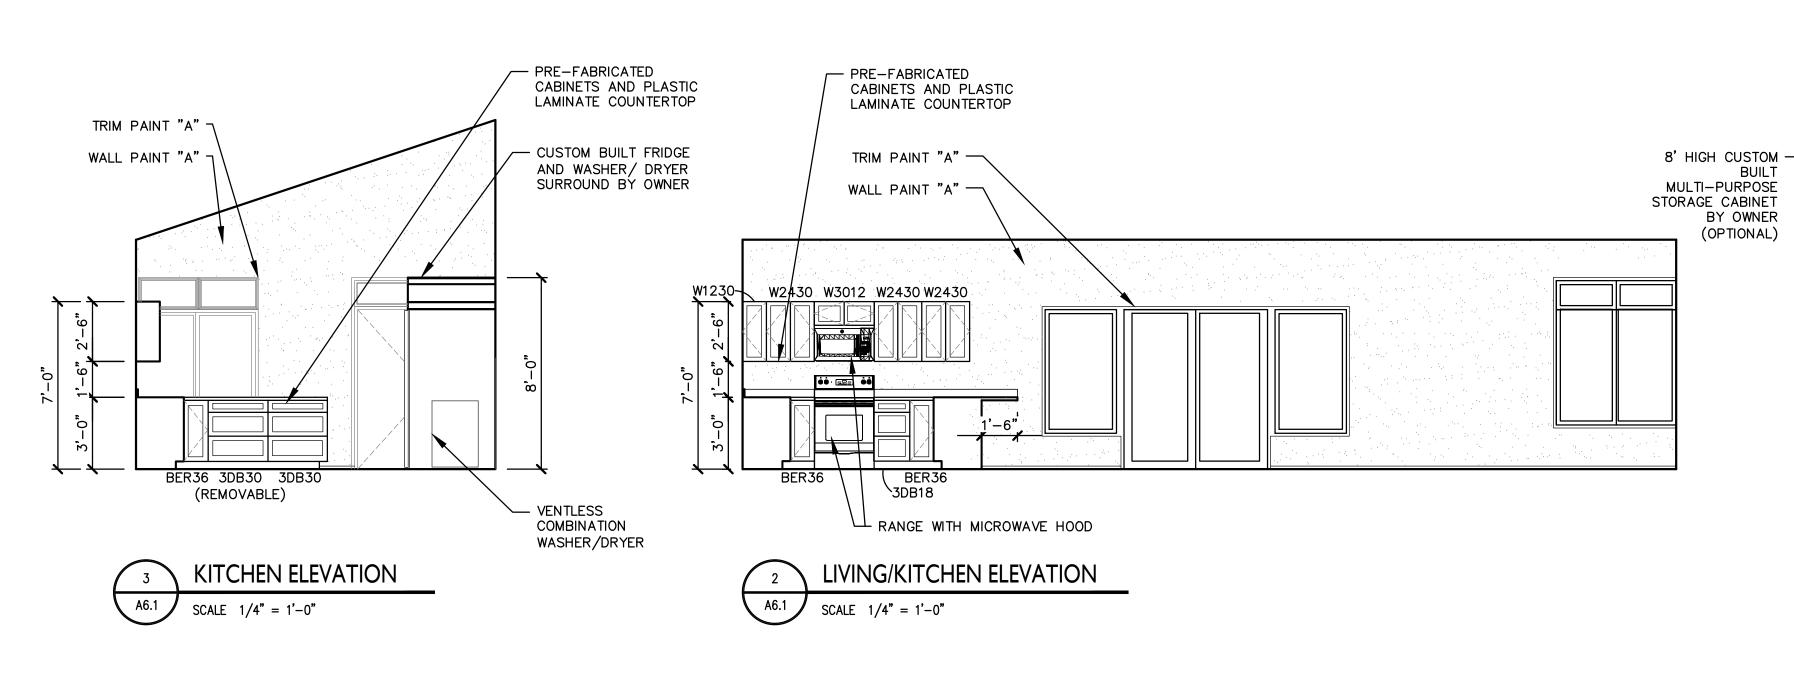
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NOTES: 1. WINDOWS AT FIRST FLOOR TO BE PELLA ENCOMPASS ENERGY STAR. 2.BASEMENT EGRESS WINDOW TO BE PELLA 250 SERIES, ENERGY STAR. 3.SLIDING DOOR TO BE PELLA ENCOMPASS ENERGY STAR. 4.FRONT DOOR AND TRANSOM TO BE FLUSH ENTRY DOOR BY THERMA-THRU. 5.GARAGE DOOR TO BE FLUSH PANEL OVERHEAD DOOR BY C.H.I. 6.SEE GENERAL NOTES ON SHEET A1.0 FOR ADDITIONAL INFORMATION. 7.BUILDER TO VERIFY ROUGH OPENING SIZES. FIXED FIXED | FIXED 6'-0" 3'-0" 5'-0" EGRESS CASEMENT GLIDING GLIDING SLIDING PATIO FIXED GLIDING \bigcirc

WINDOW & EXTERIOR DOOR TYPES







MARK NO. OF STUDS & SPACING SPECIES & GRADE	WALL SCHEDUL	LE	
W1 2V4 @ 16"	MARK	NO. OF STUDS & SPACING	SPECIES & GRADE
W1	W1	2X4 @ 16"	NO. 2 D.F.
W2 (2) 2x4 @ 16" NO. 2 D.F.	W2	(2) 2x4 @ 16"	NO. 2 D.F.

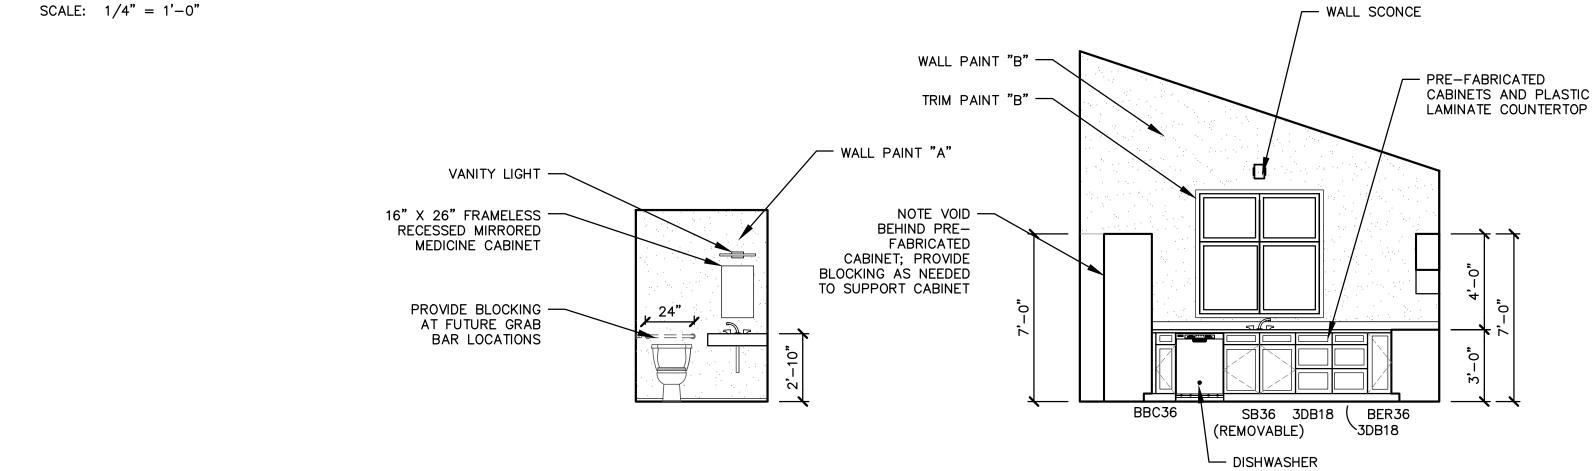NOTE: ALL WALLS TO BE 2X4 @ 2'-0" D.F. NO. 2 U.N.

BEAM SCHEDULE						
MARK	SIZE	SPECIES & GRADE				
B1	(2) 2X8	SPF NO. 2				
B2	(2) 2X10	SPF NO. 2				
В3	(2) 2X12	SPF NO. 2				
B4	(3) 2X12	SPF NO. 2				
B5	(2) 1 $\frac{3}{4}$ X 9 $\frac{1}{2}$	1.9E LVL MICROLAM				
B6	(3) 1 $\frac{3}{4}$ " X 9 $\frac{1}{2}$ "	1.9E LVL MICROLAM				

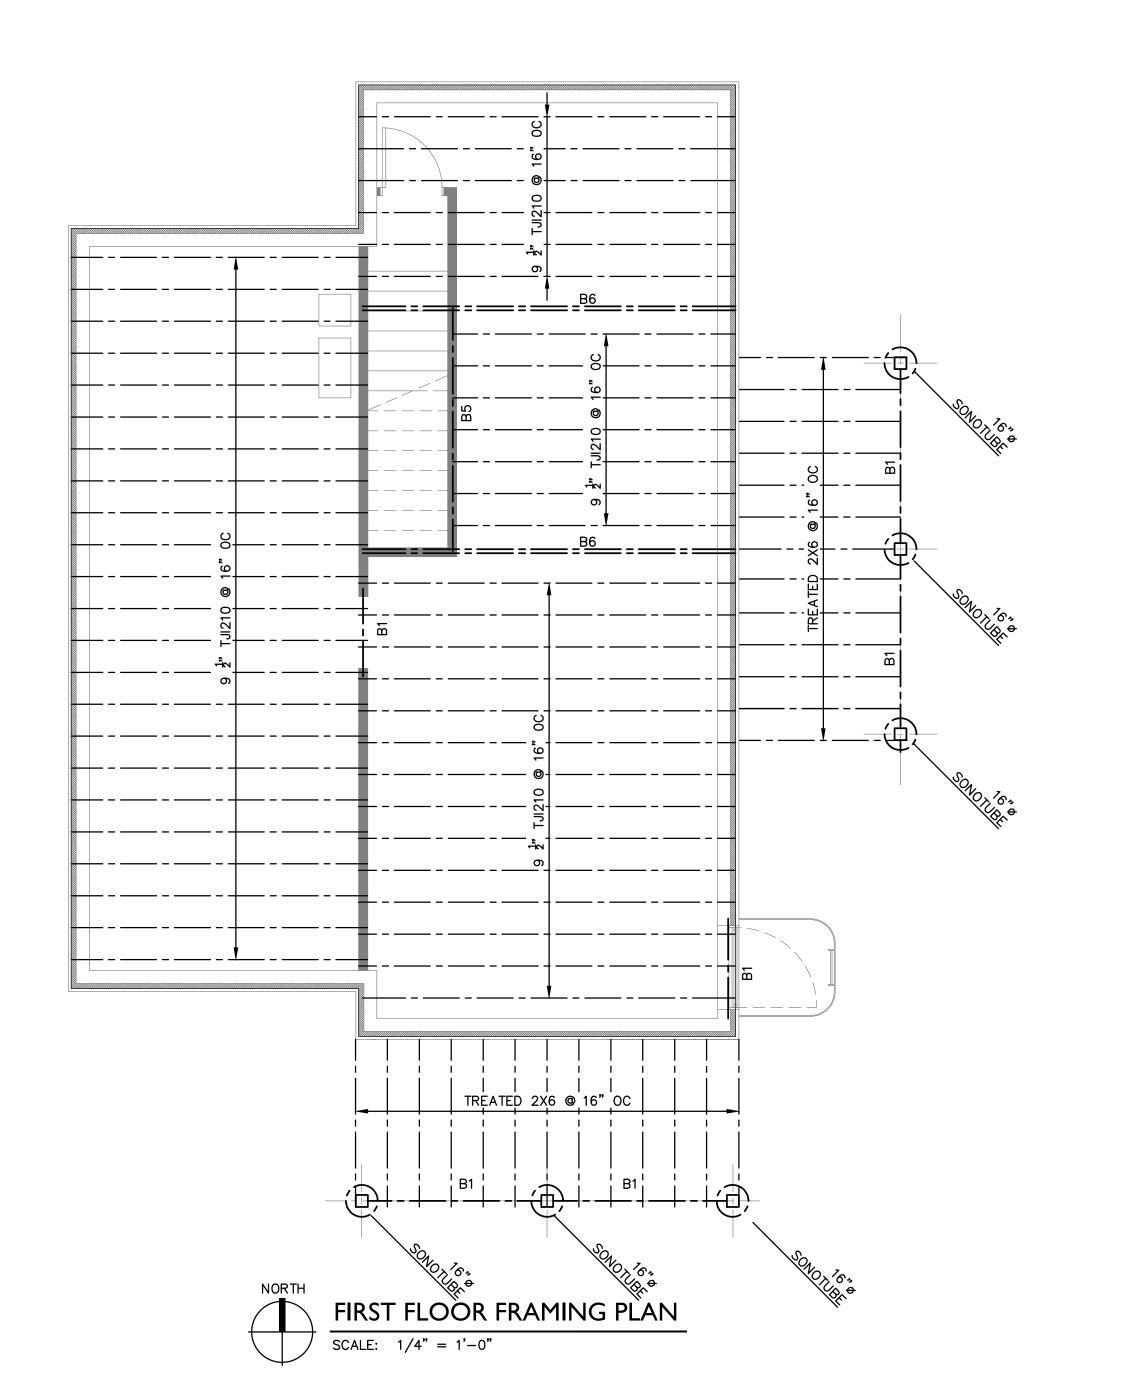

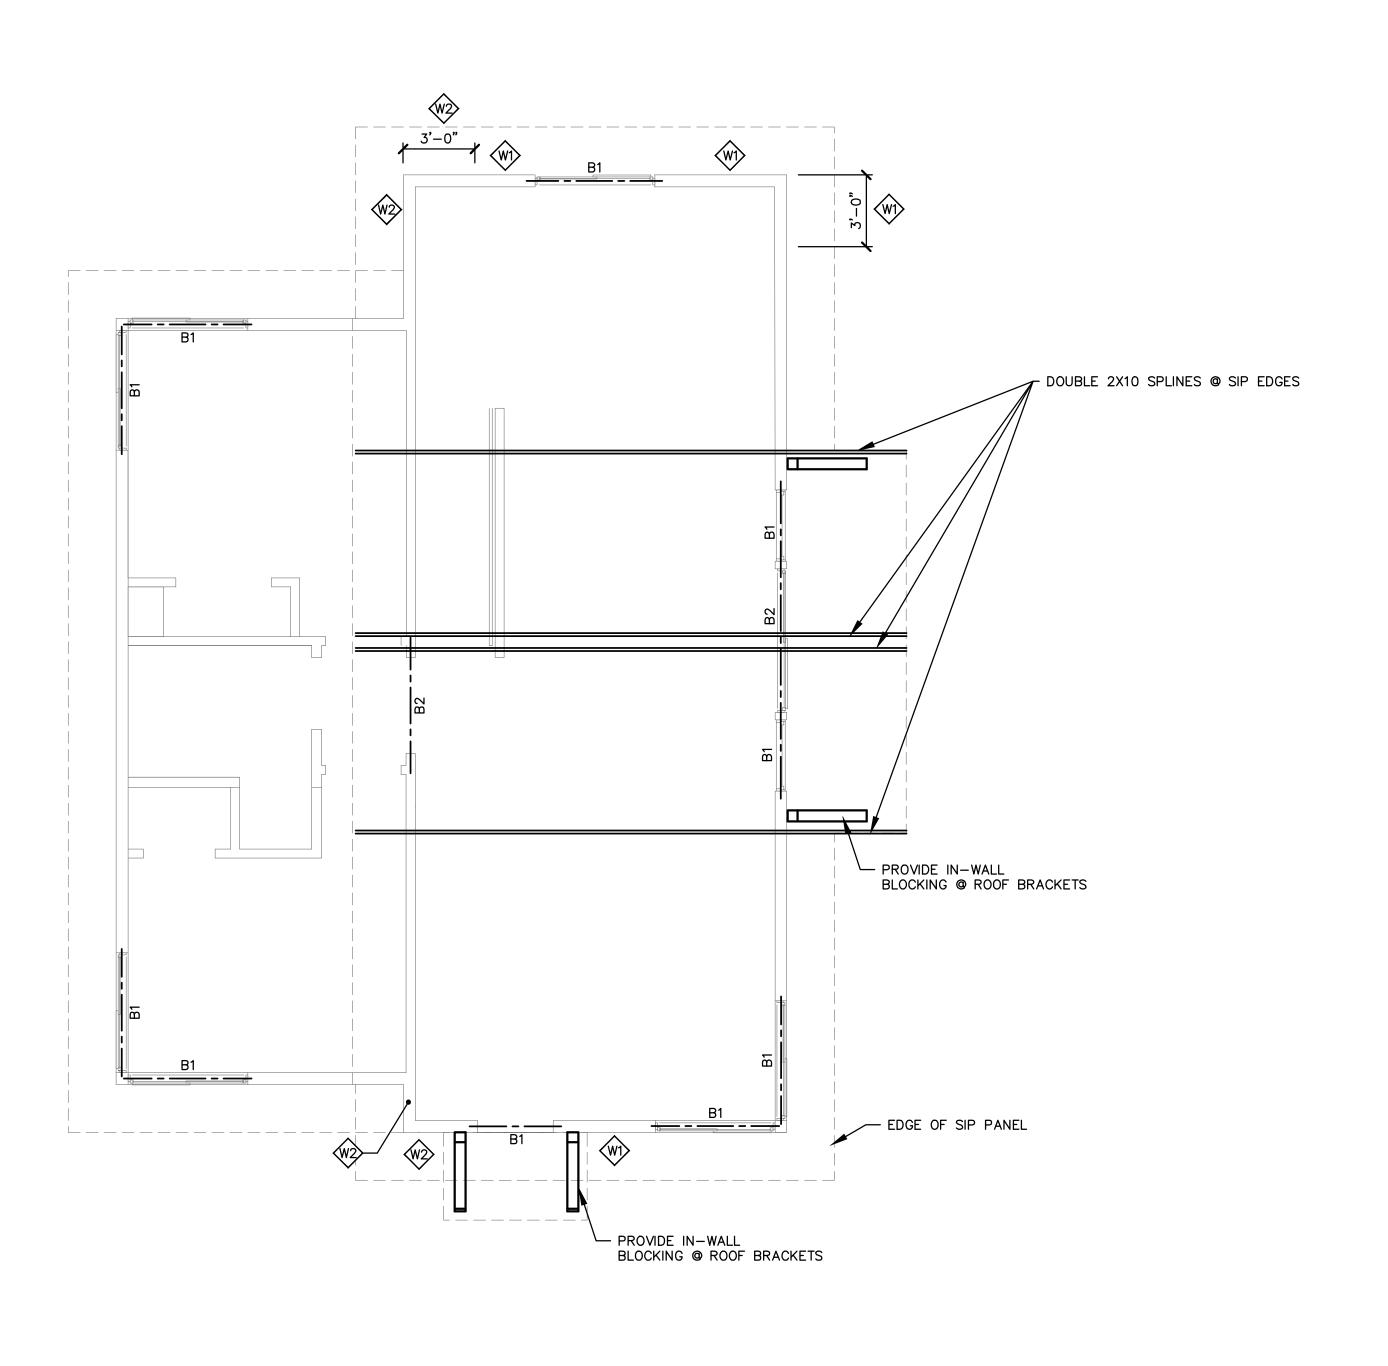




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Project 1	Dett	son	ENTER DATA IN PINK	CEUS - HIDE UNNECE	SSARY LINES			ET SHOULD BE AT LER: CONTACT DU					ICT LENGHTS OR P	OSITIONS		
Season S					NOTE TO INSTALLER: THIS SYSTEM MUST BE INSTALLED ACCORDING TO INSTRUCTIONS IN SMART DUCT MANUAL X40240					AL X40240	Ref#					
Fact Part	Builder		Kalama	zoo County La	and Bank			SEE INSPECTION SHE	ETAT THE END OF THE	SMART DI	JET MANUAL			Designer	Kas	sandra
Fact Part	heat loss	22375	CFM/ton required	400	Furnace type	Gas						# of zones	1			
Conting Cont	heat gain	14024	Furnace orientation	Upflow										[
Conting Cont					5											
CAMPUN C	Furnace	C030-M-V	Output	28860	CFM heat	420]							
County C	Cooling	COND-18	Output	18000	CFM cool	600			l							
Section	CFM/BTU (Cool):	0.0333			Nom. Calc. CFM	593						_			2	
Procession Pro	CFM/BTU (Heat):	0.0146			Max system CFM	600			8:	Approx # d	Musers	18	Real # diffusers	21		
Second Pending real Pending re			Load	(BTU)	9		8		60	AR SET	Air d	stribution	86 8	4	10	Terror and
Basement		100	2	0.000 Ox	W 45	rss a	705 325	15		500000000000000000000000000000000000000	Ü 57 mi		rs:			diffuser
Description 2027 3930 1486 5 1900 40/00/0 30 0 1 13 3 1 2	Rasement	Heating design	Heating real	ratio heating	Cooling design	Cooling real	ratio cooling	CFM Heat design	CFM Cool design	trunk	Flex length (')	CFM	Max design CFM	of diffusers	diffusers	(y or n)
Affiliary 1515 955 955 1518 955 955 1518 955 9	basement	2052	3030	1489	0	1890	ADIV/01	30					- 30	1	1 33	2
	diffusers								8	1	35				8	
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1515	Living	4247			3978			62	133				133	7		6
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Trunk Diameter TOTAL CFM Max CFM/trunk Length (feet) Elbow (90") Elbow (45") Equivalent length	Total	20396	28860	3419	12982	18000	139%	297	433	9		593	490	23	2	.1
TOWARD BECOME THE PROPERTY OF	Trunk	Diameter	TOTAL CFM	Max CFM/terink	Length (feet)	Elbow (90°)	Elbow (45°)	Equivalent length								

Dettson

Date

Project 2 Bedroom Ref#

Builder Kalamazoo County Land Bank

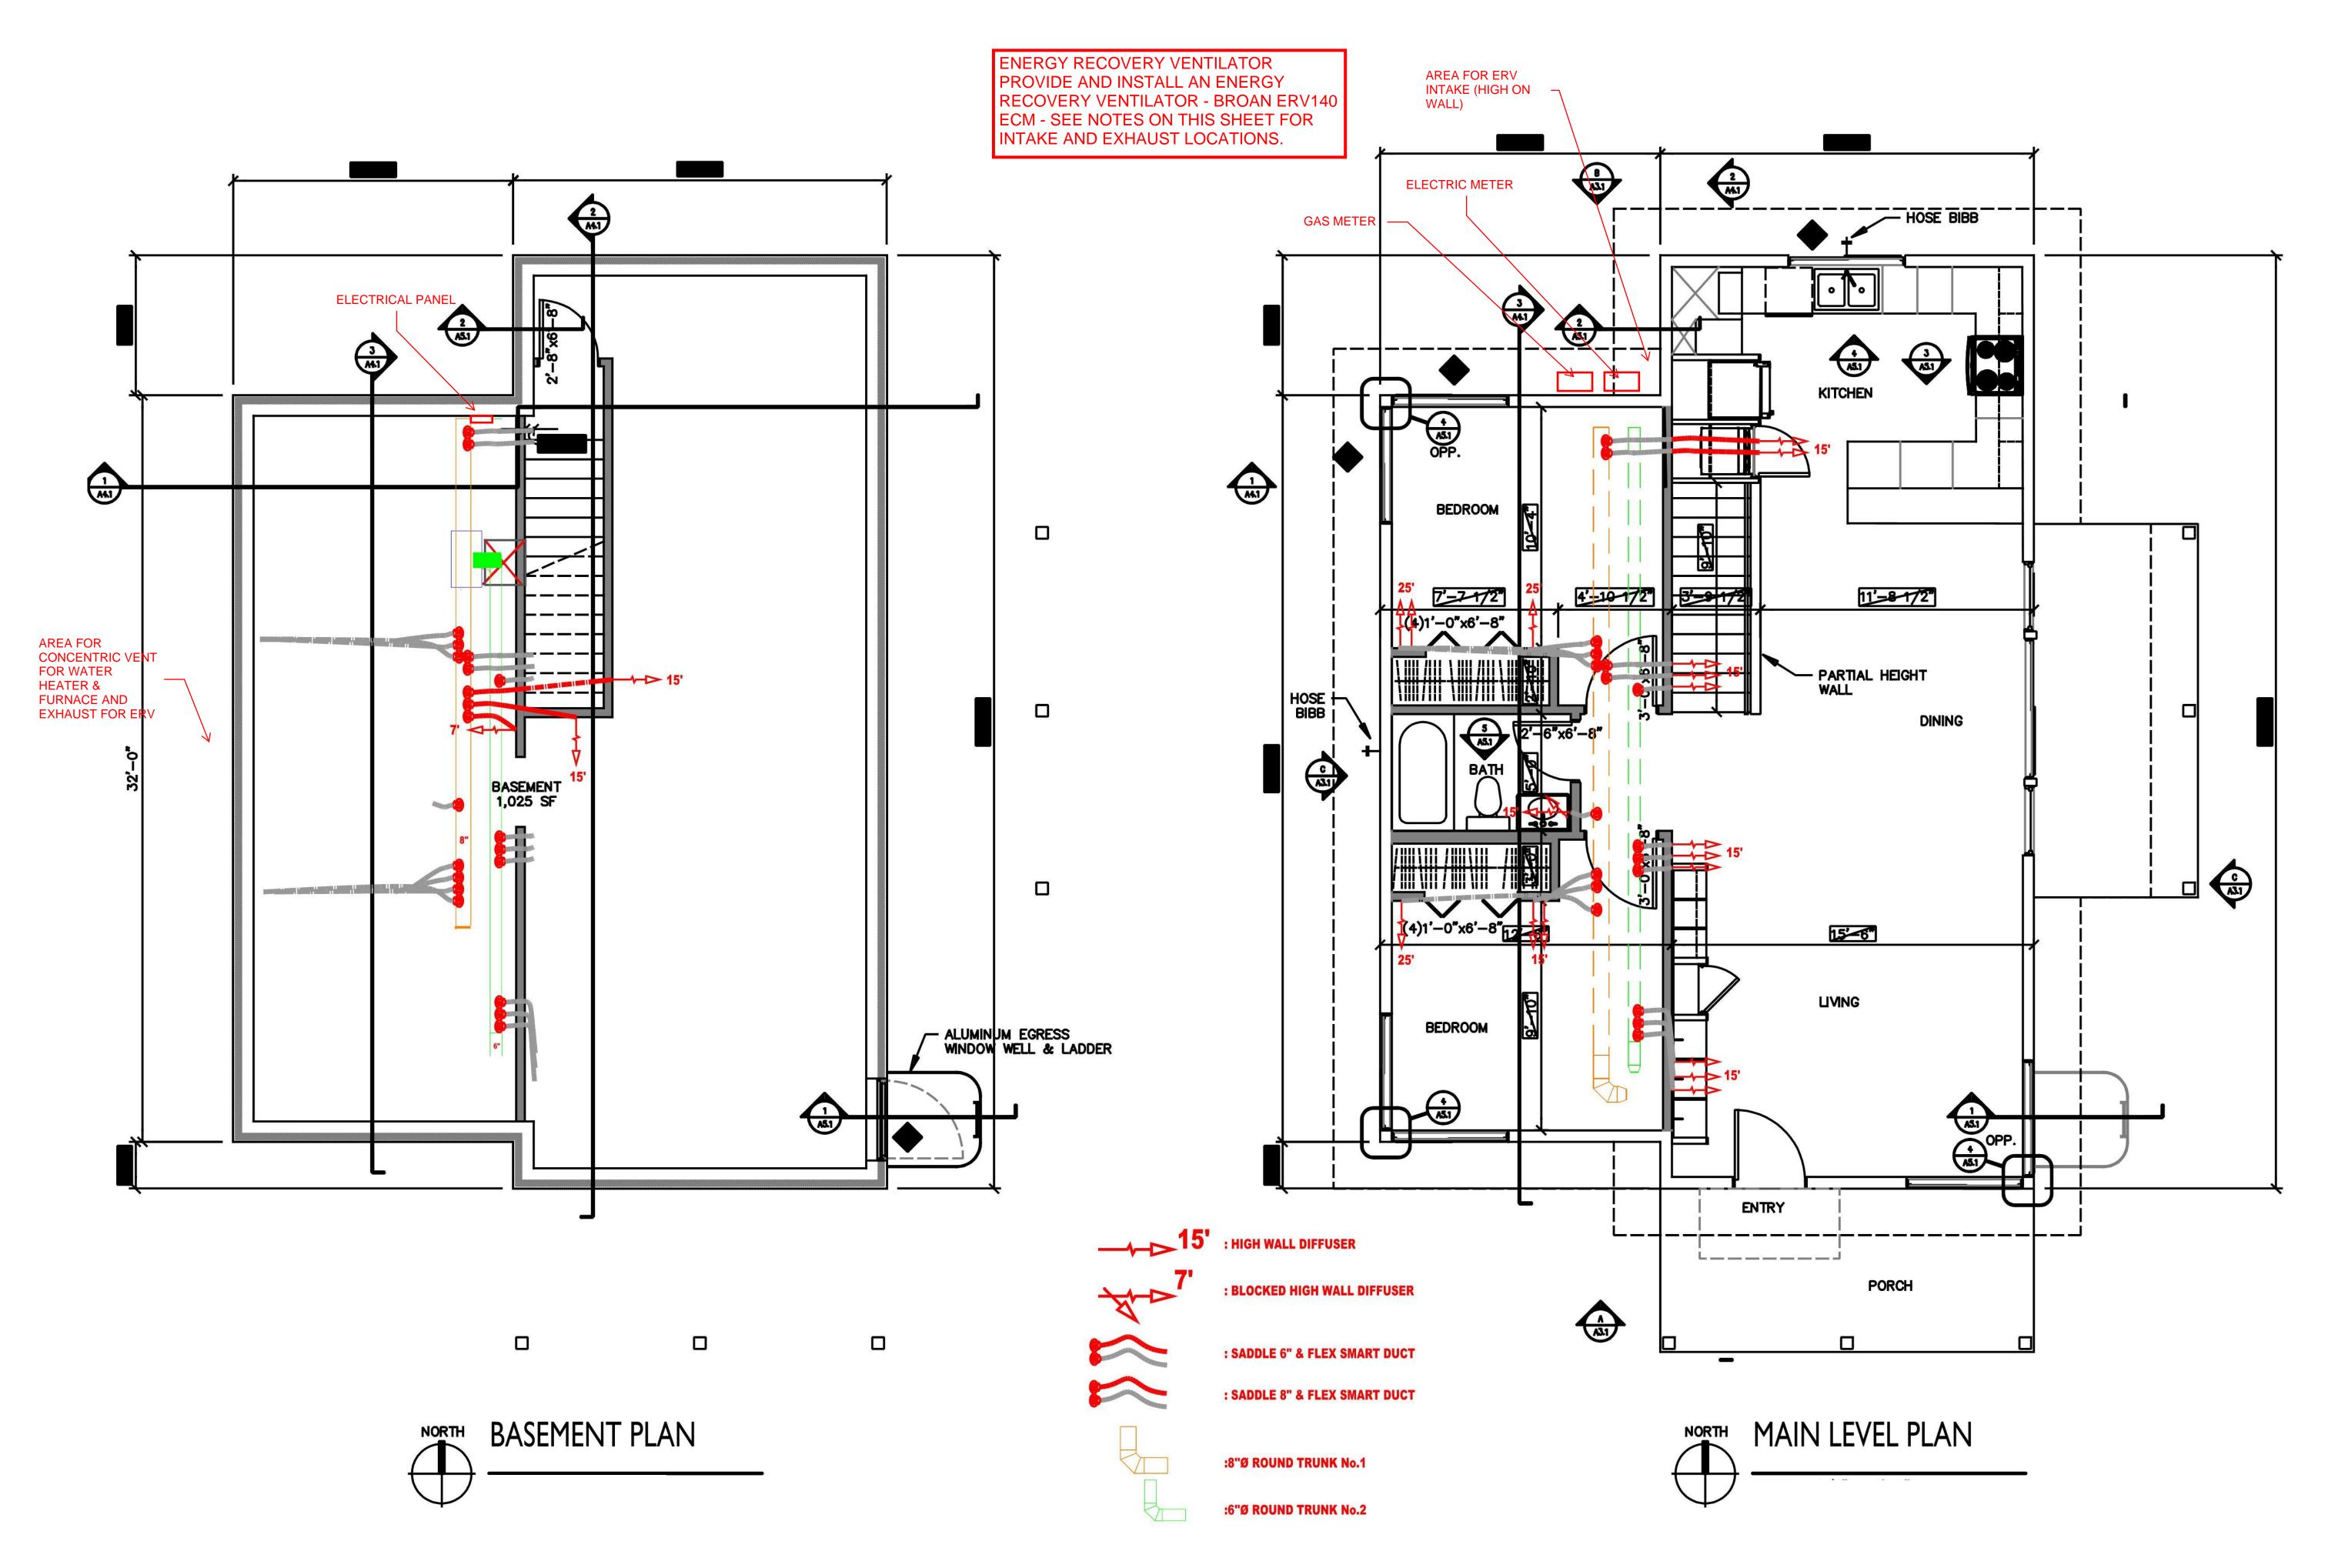HVAC in a Box bill of material; Right Sized System in combination to the Smart Duct

Product	Product Code:	Units Required:	Description:
Furnace	C030-M-V	1	Chinook 30,000 BTU modulating, 1/2 HP, 95% AFUE, 40 to 100% modulating
Alizé heat pump	COND-18	1	Outdoor condensing unit 1.5 Ton 21 SEER, 25 to 100% modulation. Includes Dettson Interface K03081
A coil - evaporator - Vertical	CC1.5-13.5-V	1	Indoor cooling coil; 1.5 Ton
A coil - evaporator - Multiposition	·		
A coil base (optional)	B40693-01	1	Evaporator Support
Communicating Thermostat	R02P032	1	
Modulating Thermostat			
Two stage Thermostat	Ť		
Smart Duct 15'	Z13I012	7	15ft of flex duct 2.5 dia.
Smart Duct 25'	Z13I008	16	25ft of flex duct 2.5 dia.
6" Saddle	B40705	8	To connect Flex Smart Duct to a 6 in dia. trunk
8" Saddle	B40706	15	To connect Flex Smart Duct to a 8 in dia. trunk
90 deg collar	B40736	23	Collar attaching the Smart duct to the wall with a 90 deg. elbow
Diffusor	B40708	23	Screwed to the collar on the face of the wall
Temporary construction cap	B40759	21	Installed to the collar temporarily during construction to prevent debris entering the system
Diffusor Restrictor	B40701	21	Blank over the diffuser with different knockouts sizes for inspector
Bottom return furnace base (optional)	B40691-01	1	Bottom Return Base
Downflow base (optional)			(ALO) (ADO) (ALO)
Zoning system (optional)	9	10	
Zoning distribution box (optional)		- F	

For saddles, Smart ducts, collars and diffusors, 10% more matl is added than required in case of damaged material on job site.

Length of each cut = total used --> loss 6x 25 = 25 --> 0 1x 25 = 15 + 7 --> 3 6x 25 = 15 --> 10 7x 15 = 15 --> 0 IN-FORM architecture

401 e. michigan ave kalamazoo, mi 49007 269.270.3331 www.informarchitect.com

New Construction:

Eastside Gateway Project

2 Bedrooms

sheet name

project number 18016

drawing date

7.3.18

sheet number

M1.2